

NOTE - WALL DIMENSIONS ARE TAKEN FROM CENTERLINE OF FRAMING OR FACE OF **GENERAL NOTES -**

> BUILDER QUALIFICATIONS THIS PLAN IS INTENDED FOR USE BY PERSONS KNOWLEDGEABLE IN AND FAMILIAR WITH GENERALLY ACCEPTED METHODS, TECHNIQUES AND STANDARDS NECESSARY FOR THE CONSTRUCTION OF THIS STRUCTURE.

2. BUILDING CODES – - ALL WORK TO BE COMPLETED IN ACCORDANCE WITH THE CURRENT NATIONAL BUILDING CODE OF CANADA.

- ALL FEDERAL, PROVINCIAL AND LOCAL ORDINANCES, ETC., SHALL BE CONSIDERED AS SPECIFICATIONS FOR THIS STRUCTURE AND SHALL TAKE PRECEDENCE OVER ANYTHING SHOWN, DESCRIBED OR IMPLIED,


IF AND WHERE VARIANCES OCCUR. - IN THE CASE OF HIGH SNOW LOADS OR UNUSUAL SITE CONDITIONS, NON-STANDARD FOUNDATIONS OR BEAM SIZES BEYOND THE SCOPE OF NBC PART 9 TABLES, THE OWNER / BUILDER MAY BE REQUIRED TO PROVIDE AT THEIR EXPENSE, AN ENGINEER'S REPORT.
PLEASE CONSULT WITH LOCAL BUILDING
AUTHORITIES.

3. ERRORS AND OMISSIONS -GREAT CARE HAS BEEN TAKEN IN THE PRODUCTION OF PLANS FOR THIS PROJECT, BUT THERE ALWAYS EXISTS THE SMALL POSSIBILITY FOR ERRORS. IT IS VERY IMPORTANT THAT THE BUILDER CAREFULLY REVIEW & CHECK ALL DETAILS AND INFORMATION ON THIS PLAN INCLUDING DIMENSIONING PRIOR TO PROCEEDING WITH CONSTRUCTION. RESPONSIBILITY MUST LIE WITH THE BUILDER. HOWEVER, ANY ERRORS OR OMISSIONS FOUND SHOULD BE REPORTED IMMEDIATELY TO B&L HOUSE PLANS PRIOR TO CONSTRUCTION.

4. B&L HOUSE PLANS SHALL NOT BE RESPONSIBLE FOR EXISTING SITE CONDITIONS SUCH AS SOIL BEARING CAPACITY, WATER TABLE, BURIED STRUCTURES, OR PROXIMITY TO PROPERTY

5. CARBON MONOXIDE DETECTORS TO BE INSTALLED ON EACH LEVEL ADJACENT TO BEDROOMS AND WHERE PROPANE FIREPLACE, GAS AND WOOD BURNING APPLIANCES ARE USED.

6. ALL DRAWINGS REMAIN THE PROPERTY OF 'B&L HOUSE PLANS'

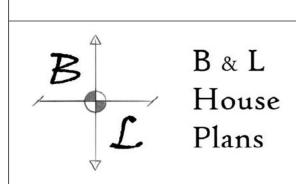


BRYDON.HUNTLEY@GMAIL.COM

EVERGREEN PHASE 2 4 UNIT APT BUILDING -(UNITS 1A - 4B)

DRAWING NAME -

3D PERSPECTIVES

ILLVIO	ON TABLE -		
REV#	RE\	VISION	DATE
1	ISSUED FOR CONST.		JAN 19, 2024
2	ISSUED F	OR PERMIT	JAN 24, 2025
3	ISSUED F	OR PERMIT	APR 2, 2025
4	EGRESS WINDOWS, 5/8" DENSGLASS, ROOF VENTS		APR 16, 2025
5	MISC REVISIONS		APR 24, 2025
6	REMOVED WET BARS		APR 28, 2025
7	ADDED 4	UNITS	AUG 14, 2025
SCALE:		SHEET:	
1/4"	= 1'	PAGE 1 (DF 12

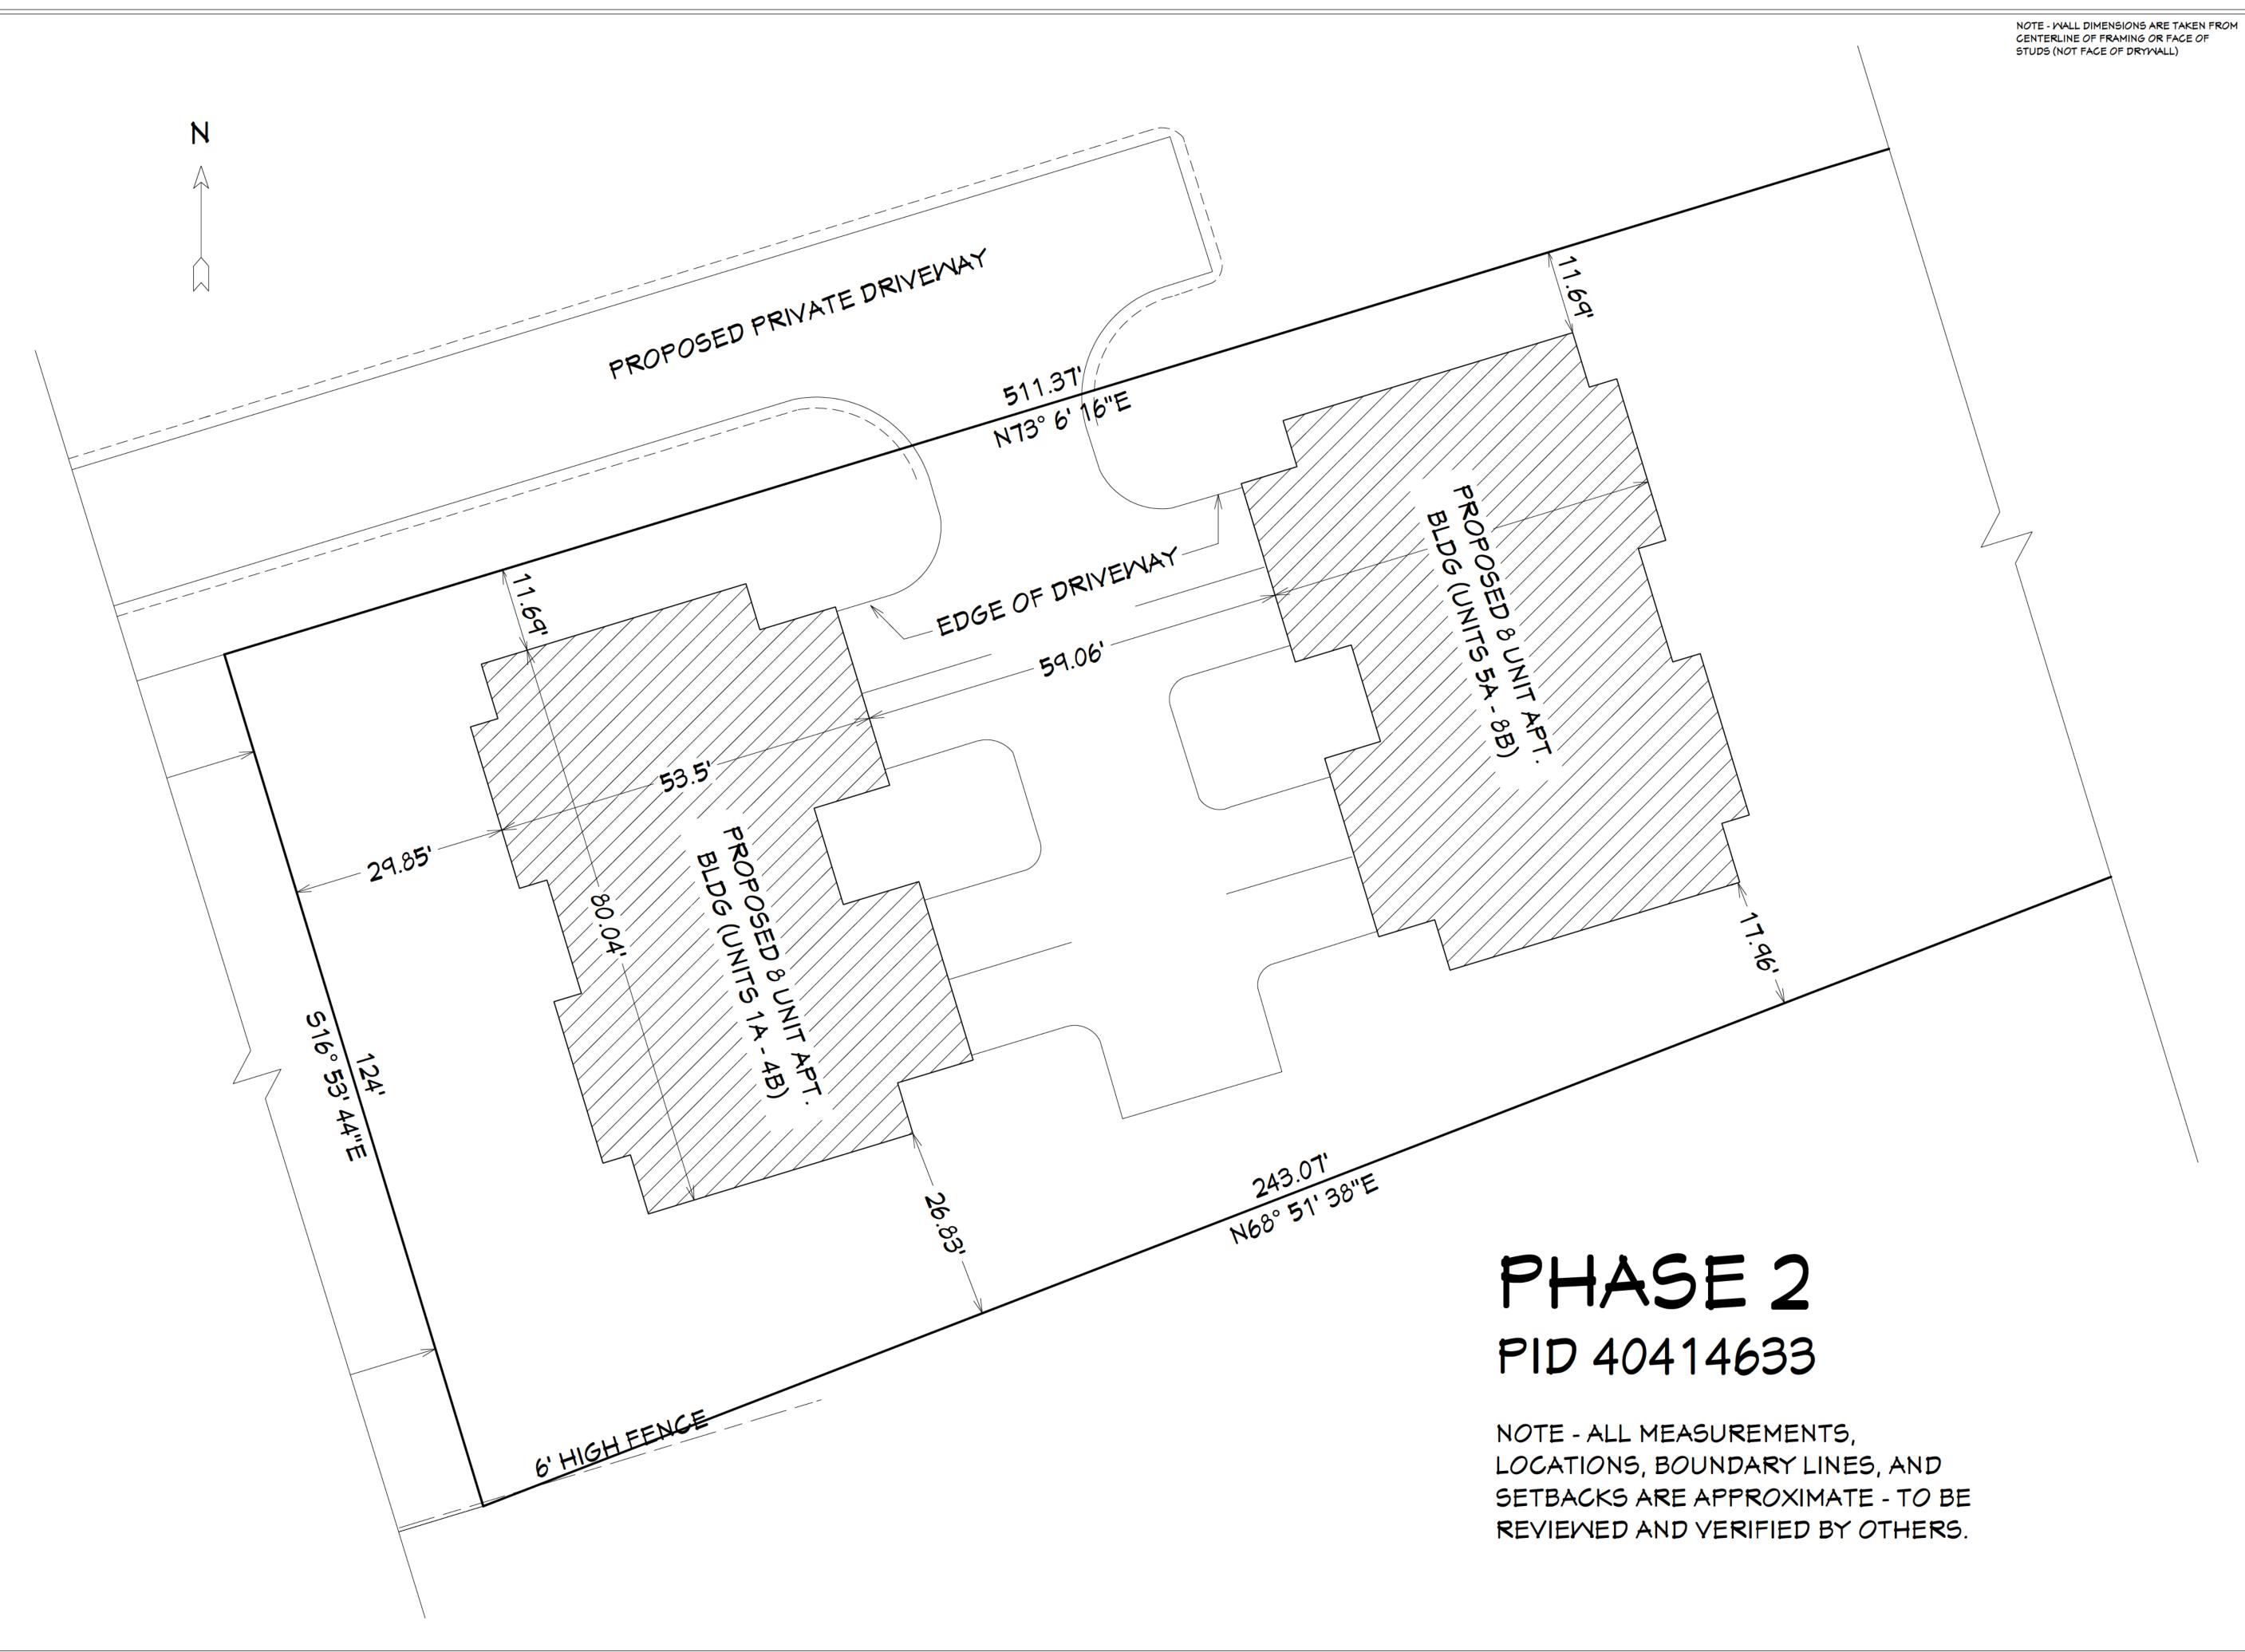

GENERAL NOTES -

1. BUILDER QUALIFICATIONS THIS PLAN IS INTENDED FOR USE BY
PERSONS KNOWLEDGEABLE IN AND FAMILIAR
WITH GENERALLY ACCEPTED METHODS,
TECHNIQUES AND STANDARDS NECESSARY
FOR THE CONSTRUCTION OF THIS
STRUCTURE.

2. BUILDING CODES -

- ALL WORK TO BE COMPLETED IN
ACCORDANCE WITH THE CURRENT NATIONAL
BUILDING CODE OF CANADA.
- ALL FEDERAL, PROVINCIAL AND LOCAL
ORDINANCES, ETC., SHALL BE CONSIDERED
AS SPECIFICATIONS FOR THIS STRUCTURE

AND SHALL TAKE PRECEDENCE OVER
ANYTHING SHOWN, DESCRIBED OR IMPLIED,
IF AND WHERE VARIANCES OCCUR.
- IN THE CASE OF HIGH SNOW LOADS OR
UNUSUAL SITE CONDITIONS, NON-STANDARD
FOUNDATIONS OR BEAM SIZES BEYOND THE
SCOPE OF NBC PART 9 TABLES, THE OWNER /


UNUSUAL SITE CONDITIONS, NON-STANDARD FOUNDATIONS OR BEAM SIZES BEYOND THE SCOPE OF NBC PART 9 TABLES, THE OWNER BUILDER MAY BE REQUIRED TO PROVIDE AT THEIR EXPENSE, AN ENGINEER'S REPORT. PLEASE CONSULT WITH LOCAL BUILDING AUTHORITIES.

3. ERRORS AND OMISSIONS –
GREAT CARE HAS BEEN TAKEN IN THE
PRODUCTION OF PLANS FOR THIS PROJECT,
BUT THERE ALWAYS EXISTS THE SMALL
POSSIBILITY FOR ERRORS. IT IS VERY
IMPORTANT THAT THE BUILDER CAREFULLY
REVIEW & CHECK ALL DETAILS AND
INFORMATION ON THIS PLAN INCLUDING
DIMENSIONING PRIOR TO PROCEEDING WITH
CONSTRUCTION. RESPONSIBILITY MUST LIE
WITH THE BUILDER. HOWEVER, ANY ERRORS
OR OMISSIONS FOUND SHOULD BE
REPORTED IMMEDIATELY TO B&L HOUSE
PLANS PRIOR TO CONSTRUCTION.

4. B&L HOUSE PLANS SHALL NOT BE RESPONSIBLE FOR EXISTING SITE CONDITIONS SUCH AS SOIL BEARING CAPACITY, WATER TABLE, BURIED STRUCTURES, OR PROXIMITY TO PROPERTY LINES.

5. CARBON MONOXIDE DETECTORS TO BE INSTALLED ON EACH LEVEL ADJACENT TO BEDROOMS AND WHERE PROPANE FIREPLACE, GAS AND WOOD BURNING APPLIANCES ARE USED.

6. ALL DRAWINGS REMAIN THE PROPERTY OF 'B&L HOUSE PLANS'

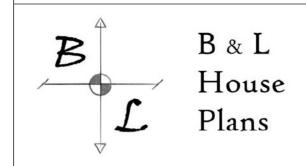

BRYDON.HUNTLEY@GMAIL.COM

PROJECT NAME -

EVERGREEN PHASE 2 4 UNIT APT BUILDING -(UNITS 1A - 4B)

DRAWING NAME -

SITE PLAN

REVISION TABLE -				
REV#	RE	/ISION	DATE	
1	ISSUED FOR CONST.		JAN 19, 2024	
2	ISSUED F	OR PERMIT	JAN 24, 2025	
3	ISSUED F	OR PERMIT	APR 2, 2025	
4	EGRESS WINDOWS, 5/8" DENSGLASS, ROOF VENTS		APR 16, 2025	
5	MISC REVISIONS		APR 24, 2025	
6	REMOVED WET BARS		APR 28, 2025	
7	ADDED 4 UNITS		AUG 14, 2025	
SCALI	E :	SHEET:		
3/32	" = 1'	PAGE 2 (OF 12	



GENERAL NOTES -

1. BUILDER QUALIFICATIONS THIS PLAN IS INTENDED FOR USE BY
PERSONS KNOWLEDGEABLE IN AND FAMILIAR
WITH GENERALLY ACCEPTED METHODS,
TECHNIQUES AND STANDARDS NECESSARY
FOR THE CONSTRUCTION OF THIS
STRUCTURE.

2. BUILDING CODES -

- ALL WORK TO BE COMPLETED IN
ACCORDANCE WITH THE CURRENT NATIONAL
BUILDING CODE OF CANADA.
- ALL FEDERAL, PROVINCIAL AND LOCAL
ORDINANCES, ETC., SHALL BE CONSIDERED

AS SPECIFICATIONS FOR THIS STRUCTURE AND SHALL TAKE PRECEDENCE OVER ANYTHING SHOWN, DESCRIBED OR IMPLIED, IF AND WHERE VARIANCES OCCUR.

- IN THE CASE OF HIGH SNOW LOADS OR UNUSUAL SITE CONDITIONS, NON-STANDARD FOUNDATIONS OR BEAM SIZES BEYOND THE SCOPE OF NBC PART 9 TABLES, THE OWNER /


UNUSUAL SITE CONDITIONS, NON-STANDARD FOUNDATIONS OR BEAM SIZES BEYOND THE SCOPE OF NBC PART 9 TABLES, THE OWNER BUILDER MAY BE REQUIRED TO PROVIDE AT THEIR EXPENSE, AN ENGINEER'S REPORT. PLEASE CONSULT WITH LOCAL BUILDING AUTHORITIES.

3. ERRORS AND OMISSIONS –
GREAT CARE HAS BEEN TAKEN IN THE
PRODUCTION OF PLANS FOR THIS PROJECT,
BUT THERE ALWAYS EXISTS THE SMALL
POSSIBILITY FOR ERRORS. IT IS VERY
IMPORTANT THAT THE BUILDER CAREFULLY
REVIEW & CHECK ALL DETAILS AND
INFORMATION ON THIS PLAN INCLUDING
DIMENSIONING PRIOR TO PROCEEDING WITH
CONSTRUCTION. RESPONSIBILITY MUST LIE
WITH THE BUILDER. HOWEVER, ANY ERRORS
OR OMISSIONS FOUND SHOULD BE
REPORTED IMMEDIATELY TO B&L HOUSE
PLANS PRIOR TO CONSTRUCTION.

4. B&L HOUSE PLANS SHALL NOT BE RESPONSIBLE FOR EXISTING SITE CONDITIONS SUCH AS SOIL BEARING CAPACITY, WATER TABLE, BURIED STRUCTURES, OR PROXIMITY TO PROPERTY LINES.

5. CARBON MONOXIDE DETECTORS TO BE INSTALLED ON EACH LEVEL ADJACENT TO BEDROOMS AND WHERE PROPANE FIREPLACE, GAS AND WOOD BURNING APPLIANCES ARE USED.

6. ALL DRAWINGS REMAIN THE PROPERTY OF 'B&L HOUSE PLANS'

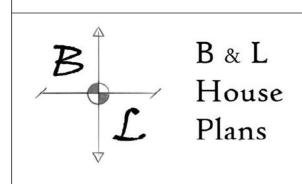

BRYDON.HUNTLEY@GMAIL.COM


PROJECT NAME -

EVERGREEN PHASE 2 4 UNIT APT BUILDING -(UNITS 1A - 4B)

DRAWING NAME -

FRONT ELEVATION

REVISION TABLE -				
REV#	REVISION		DATE	
1	ISSUED FOR CONST.		JAN 19, 2024	
2	ISSUED FOR PERMIT		JAN 24, 2025	
3	ISSUED FOR PERMIT		APR 2, 2025	
4	EGRESS V 5/8" DENS ROOF VE	APR 16, 2025		
5	MISC REVISIONS		APR 24, 2025	
6	REMOVED WET BARS		APR 28, 2025	
7	ADDED 4 UNITS		AUG 14, 2025	
SCALE:		SHEET:		
1/4" = 1'		PAGE 3 (OF 12	

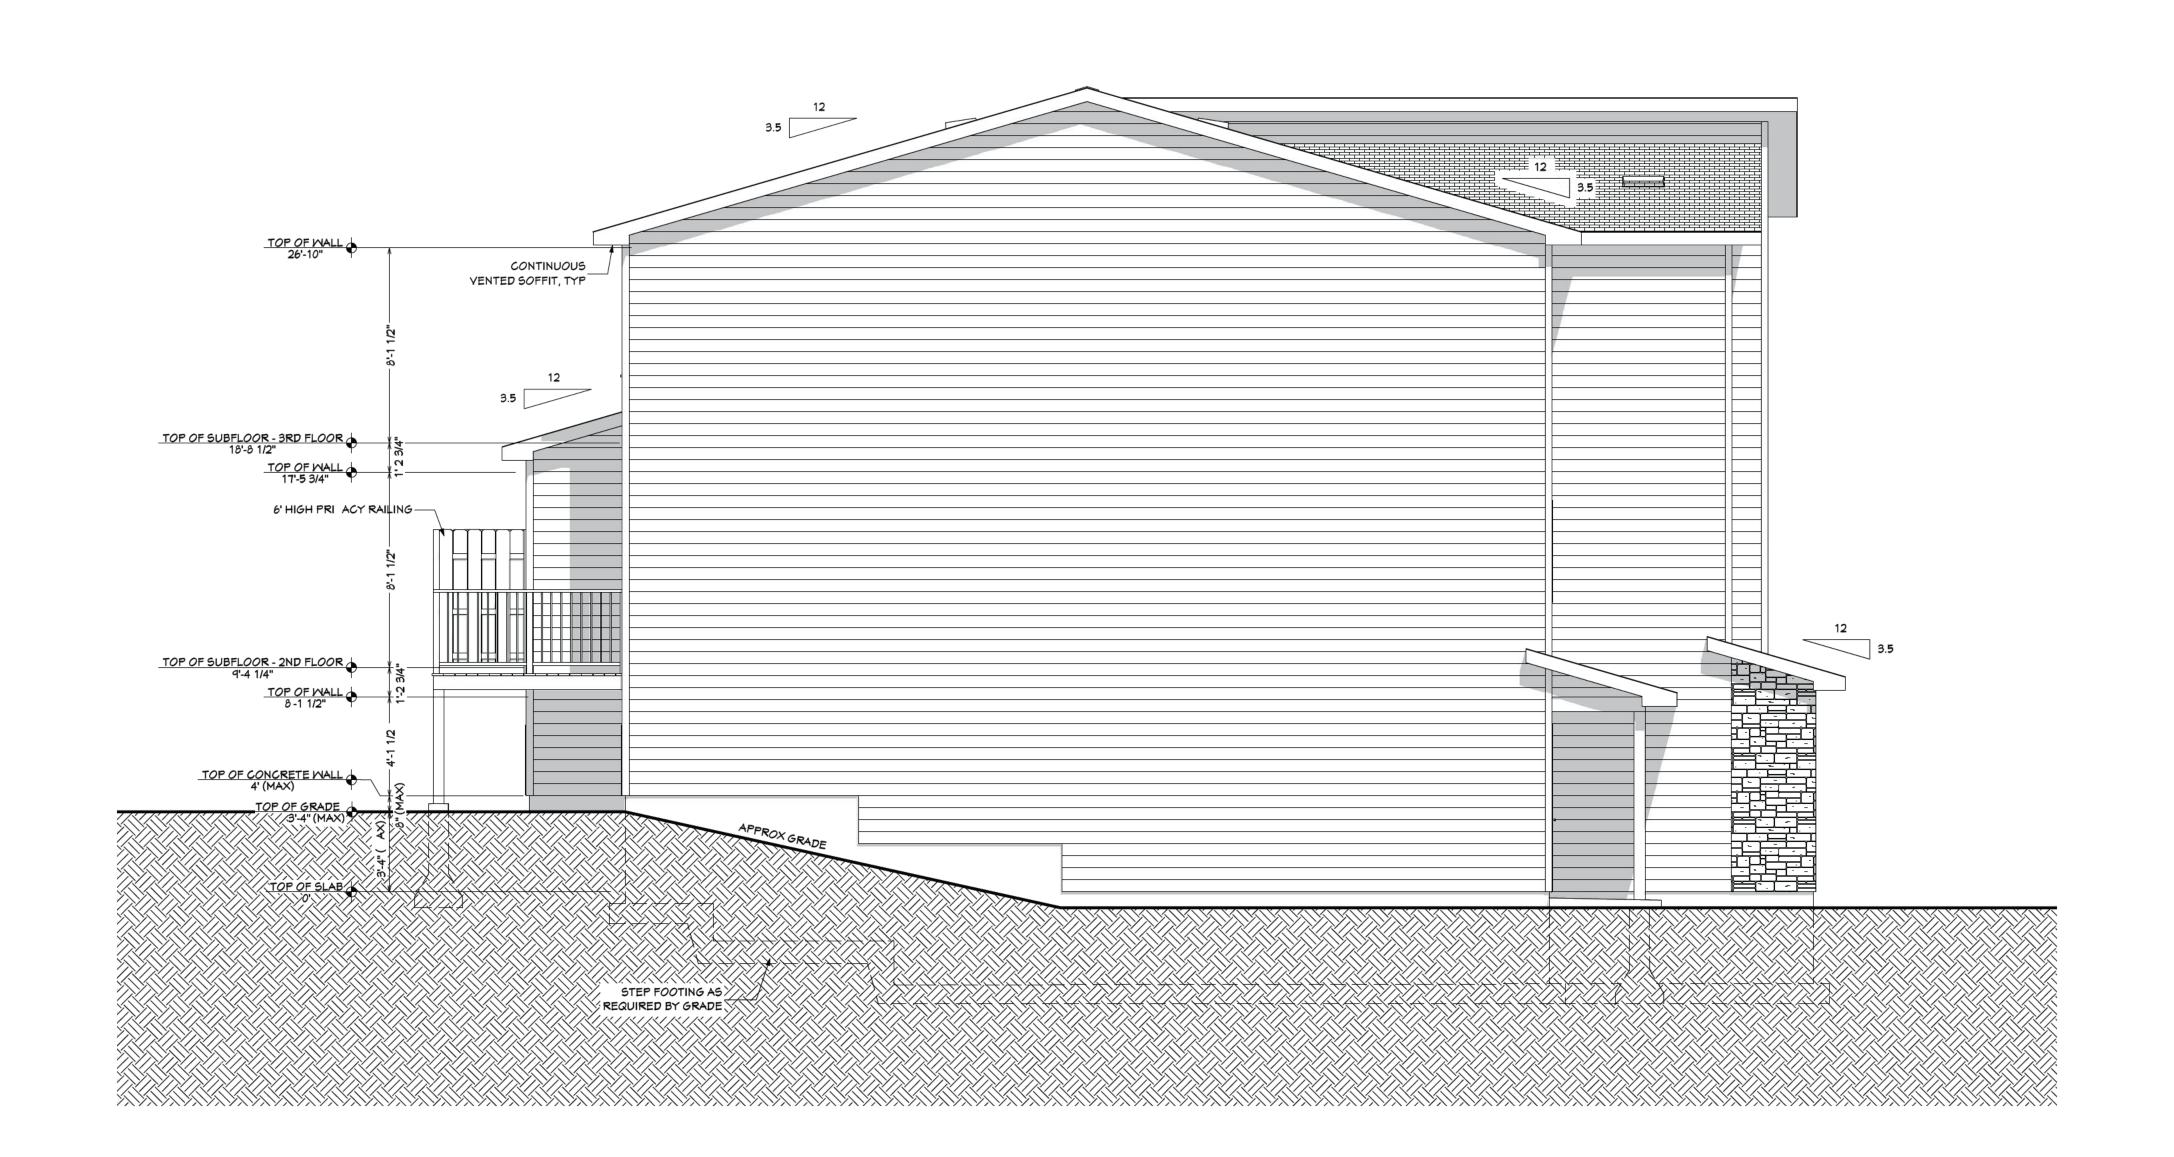

GENERAL NOTES -

1. BUILDER QUALIFICATIONS THIS PLAN IS INTENDED FOR USE BY
PERSONS KNOWLEDGEABLE IN AND FAMILIAR
WITH GENERALLY ACCEPTED METHODS,
TECHNIQUES AND STANDARDS NECESSARY
FOR THE CONSTRUCTION OF THIS
STRUCTURE.

2. BUILDING CODES –
- ALL WORK TO BE COMPLETED IN
ACCORDANCE WITH THE CURRENT NATIONAL
BUILDING CODE OF CANADA.
- ALL FEDERAL, PROVINCIAL AND LOCAL
ORDINANCES, ETC., SHALL BE CONSIDERED
AS SPECIFICATIONS FOR THIS STRUCTURE
AND SHALL TAKE PRECEDENCE OVER
ANYTHING SHOWN, DESCRIBED OR IMPLIED,
IF AND WHERE VARIANCES OCCUR.
- IN THE CASE OF HIGH SNOW LOADS OR
UNUSUAL SITE CONDITIONS, NON-STANDARD
FOUNDATIONS OR BEAM SIZES BEYOND THE

SCOPE OF NBC PART 9 TABLES, THE OWNER / BUILDER MAY BE REQUIRED TO PROVIDE AT THEIR EXPENSE, AN ENGINEER'S REPORT. PLEASE CONSULT WITH LOCAL BUILDING AUTHORITIES.

3. ERRORS AND OMISSIONS – GREAT CARE HAS BEEN TAKEN IN THE PRODUCTION OF PLANS FOR THIS PROJECT, BUT THERE ALWAYS EXISTS THE SMALL POSSIBILITY FOR ERRORS. IT IS VERY IMPORTANT THAT THE BUILDER CAREFULLY

REVIEW & CHECK ALL DETAILS AND INFORMATION ON THIS PLAN INCLUDING DIMENSIONING PRIOR TO PROCEEDING WITH

CAPACITY, WATER TABLE, BURIED


CONSTRUCTION. RESPONSIBILITY MUST LIE WITH THE BUILDER. HOWEVER, ANY ERRORS OR OMISSIONS FOUND SHOULD BE REPORTED IMMEDIATELY TO B&L HOUSE PLANS PRIOR TO CONSTRUCTION.

4. B&L HOUSE PLANS SHALL NOT BE RESPONSIBLE FOR EXISTING SITE CONDITIONS SUCH AS SOIL BEARING

5. CARBON MONOXIDE DETECTORS TO BE INSTALLED ON EACH LEVEL ADJACENT TO BEDROOMS AND WHERE PROPANE FIREPLACE, GAS AND WOOD BURNING APPLIANCES ARE USED.

STRUCTURES, OR PROXIMITY TO PROPERTY

6. ALL DRAWINGS REMAIN THE PROPERTY OF 'B&L HOUSE PLANS'

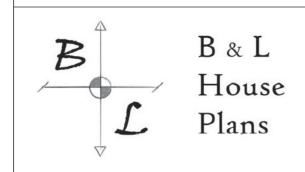

BRYDON.HUNTLEY@GMAIL.COM


PROJECT NAME -

EVERGREEN PHASE 2 4 UNIT APT BUILDING -(UNITS 1A - 4B)

DRAWING NAME -

LEFT ELEVATION

REVIS	REVISION TABLE -				
REV#	RE\	/ISION	DATE		
1	ISSUED FOR CONST.		JAN 19, 2024		
2	ISSUED F	JAN 24, 2025			
3	ISSUED F	APR 2, 2025			
4	EGRESS V 5/8" DENS ROOF VE	APR 16, 2025			
5	MISC REVISIONS		APR 24, 2025		
6	REMOVED WET BARS		APR 28, 2025		
7	ADDED 4 UNITS		AUG 14, 2025		
SCALE:		SHEET:			
1/4'' = 1'		PAGE 4 (OF 12		

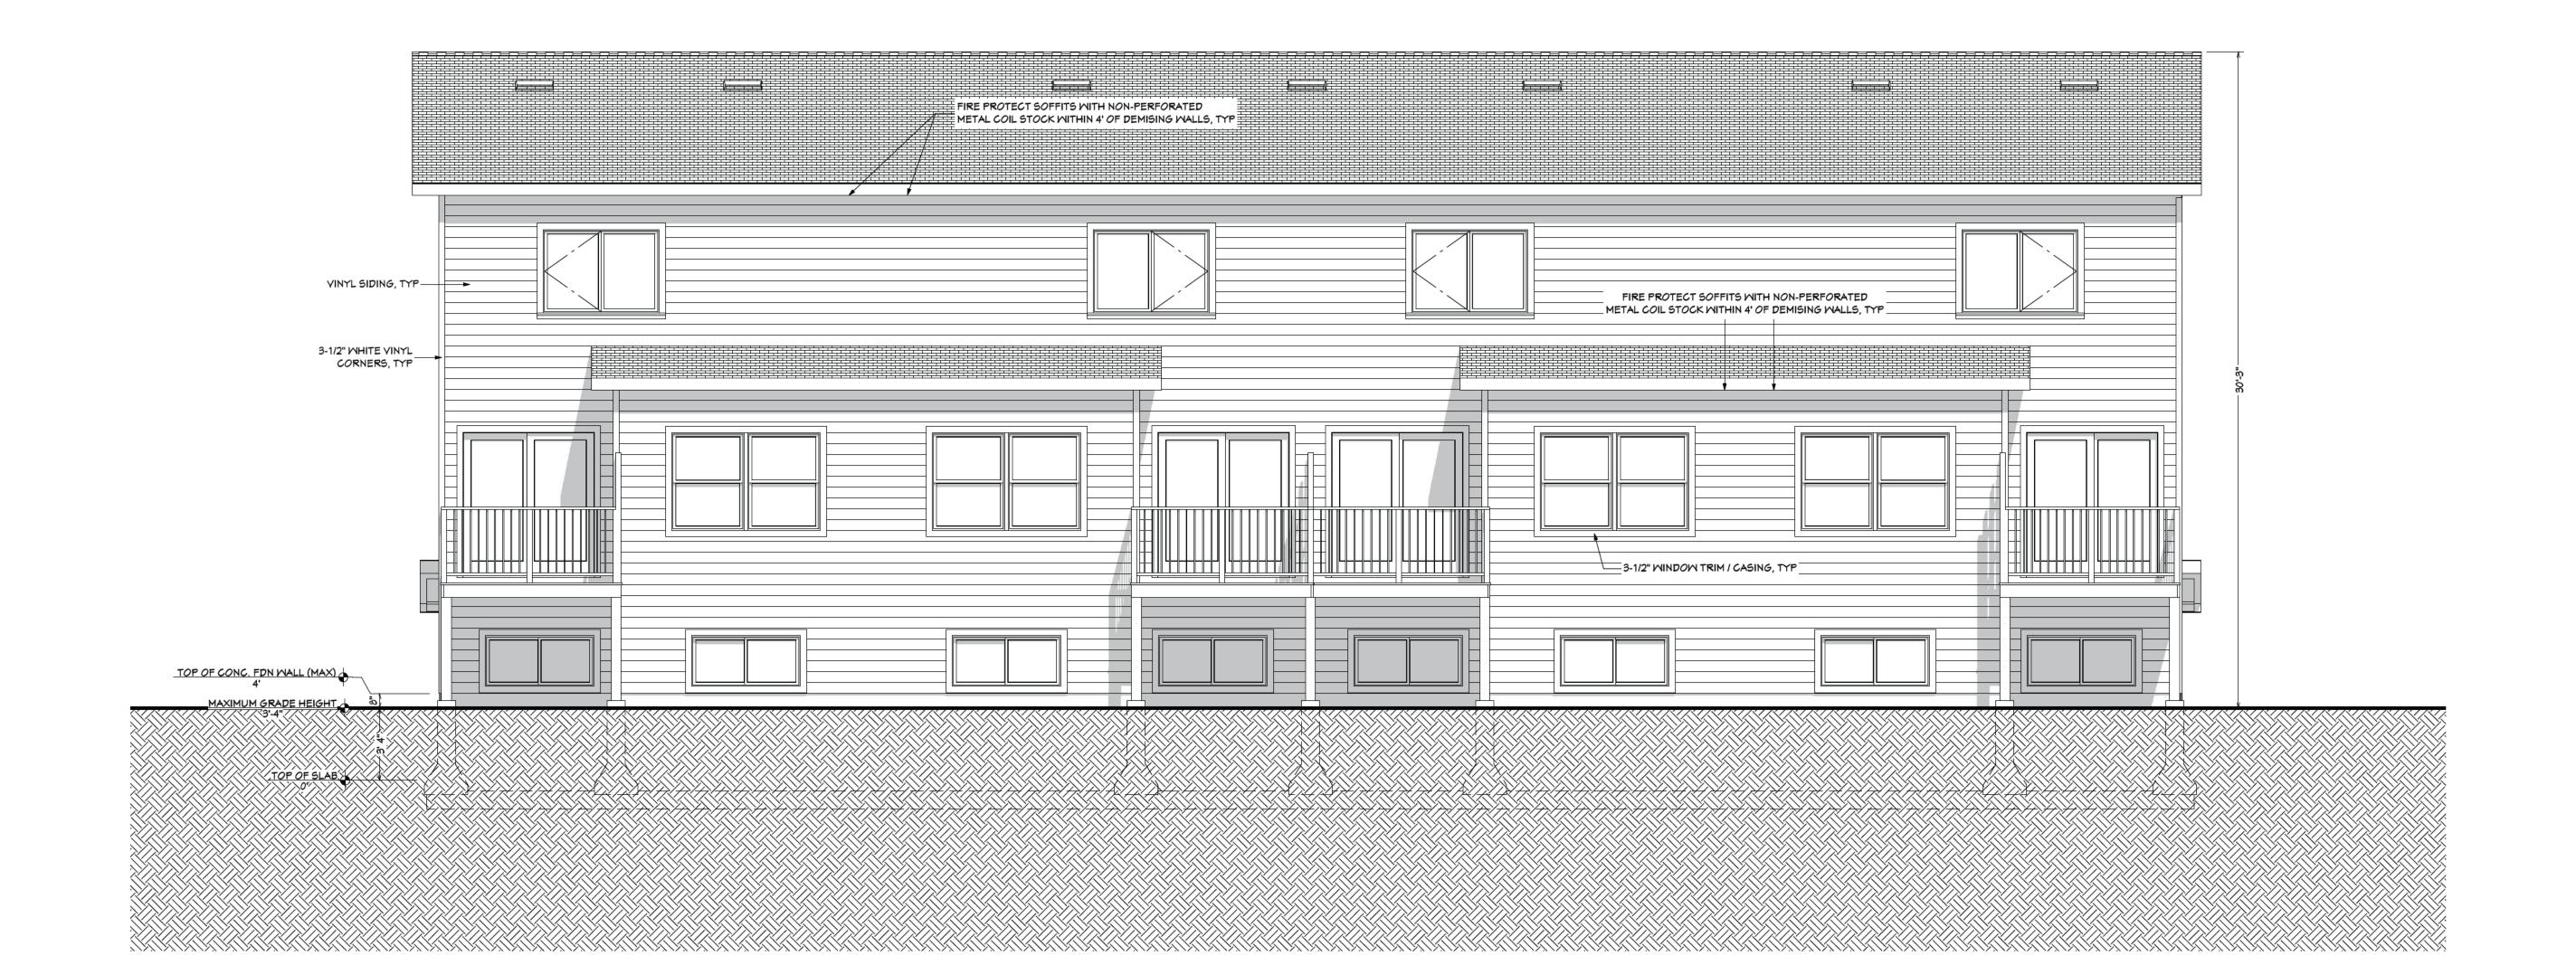

GENERAL NOTES -

2. BUILDING CODES -

1. BUILDER QUALIFICATIONS THIS PLAN IS INTENDED FOR USE BY
PERSONS KNOWLEDGEABLE IN AND FAMILIAR
WITH GENERALLY ACCEPTED METHODS,
TECHNIQUES AND STANDARDS NECESSARY
FOR THE CONSTRUCTION OF THIS
STRUCTURE.

- ALL WORK TO BE COMPLETED IN
ACCORDANCE WITH THE CURRENT NATIONAL
BUILDING CODE OF CANADA.
- ALL FEDERAL, PROVINCIAL AND LOCAL
ORDINANCES, ETC., SHALL BE CONSIDERED
AS SPECIFICATIONS FOR THIS STRUCTURE
AND SHALL TAKE PRECEDENCE OVER
ANYTHING SHOWN, DESCRIBED OR IMPLIED,
IF AND WHERE VARIANCES OCCUR.
- IN THE CASE OF HIGH SNOW LOADS OR
UNUSUAL SITE CONDITIONS, NON-STANDARD
FOUNDATIONS OR BEAM SIZES BEYOND THE


- IN THE CASE OF HIGH SNOW LOADS OR UNUSUAL SITE CONDITIONS, NON-STANDARD FOUNDATIONS OR BEAM SIZES BEYOND THE SCOPE OF NBC PART 9 TABLES, THE OWNER / BUILDER MAY BE REQUIRED TO PROVIDE AT THEIR EXPENSE, AN ENGINEER'S REPORT. PLEASE CONSULT WITH LOCAL BUILDING AUTHORITIES.

3. ERRORS AND OMISSIONS –
GREAT CARE HAS BEEN TAKEN IN THE
PRODUCTION OF PLANS FOR THIS PROJECT,
BUT THERE ALWAYS EXISTS THE SMALL
POSSIBILITY FOR ERRORS. IT IS VERY
IMPORTANT THAT THE BUILDER CAREFULLY
REVIEW & CHECK ALL DETAILS AND
INFORMATION ON THIS PLAN INCLUDING
DIMENSIONING PRIOR TO PROCEEDING WITH
CONSTRUCTION. RESPONSIBILITY MUST LIE
WITH THE BUILDER. HOWEVER, ANY ERRORS
OR OMISSIONS FOUND SHOULD BE
REPORTED IMMEDIATELY TO B&L HOUSE
PLANS PRIOR TO CONSTRUCTION.

4. B&L HOUSE PLANS SHALL NOT BE RESPONSIBLE FOR EXISTING SITE CONDITIONS SUCH AS SOIL BEARING CAPACITY, WATER TABLE, BURIED STRUCTURES, OR PROXIMITY TO PROPERTY LINES.

5. CARBON MONOXIDE DETECTORS TO BE INSTALLED ON EACH LEVEL ADJACENT TO BEDROOMS AND WHERE PROPANE FIREPLACE, GAS AND WOOD BURNING APPLIANCES ARE USED.

6. ALL DRAWINGS REMAIN THE PROPERTY OF 'B&L HOUSE PLANS'

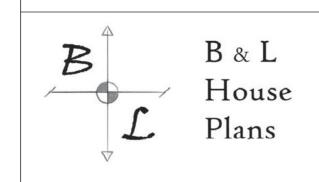

BRYDON.HUNTLEY@GMAIL.COM


PROJECT NAME -

EVERGREEN PHASE 2 4 UNIT APT BUILDING -(UNITS 1A - 4B)

DRAWING NAME -

REAR ELEVATION

REV#	RE\	DATE	
1	ISSUED FOR CONST.		JAN 19, 2024
2	ISSUED F	OR PERMIT	JAN 24, 2025
3	ISSUED F	OR PERMIT	APR 2, 2025
4	EGRESS WINDOWS, 5/8" DENSGLASS, ROOF VENTS		APR 16, 2025
5	MISC REVISIONS		APR 24, 2025
6	REMOVED WET BARS		APR 28, 2025
7	ADDED 4 UNITS		AUG 14, 2025
SCALE:		SHEET:	
1/4"	- 1!	PAGE 5 (NE 12

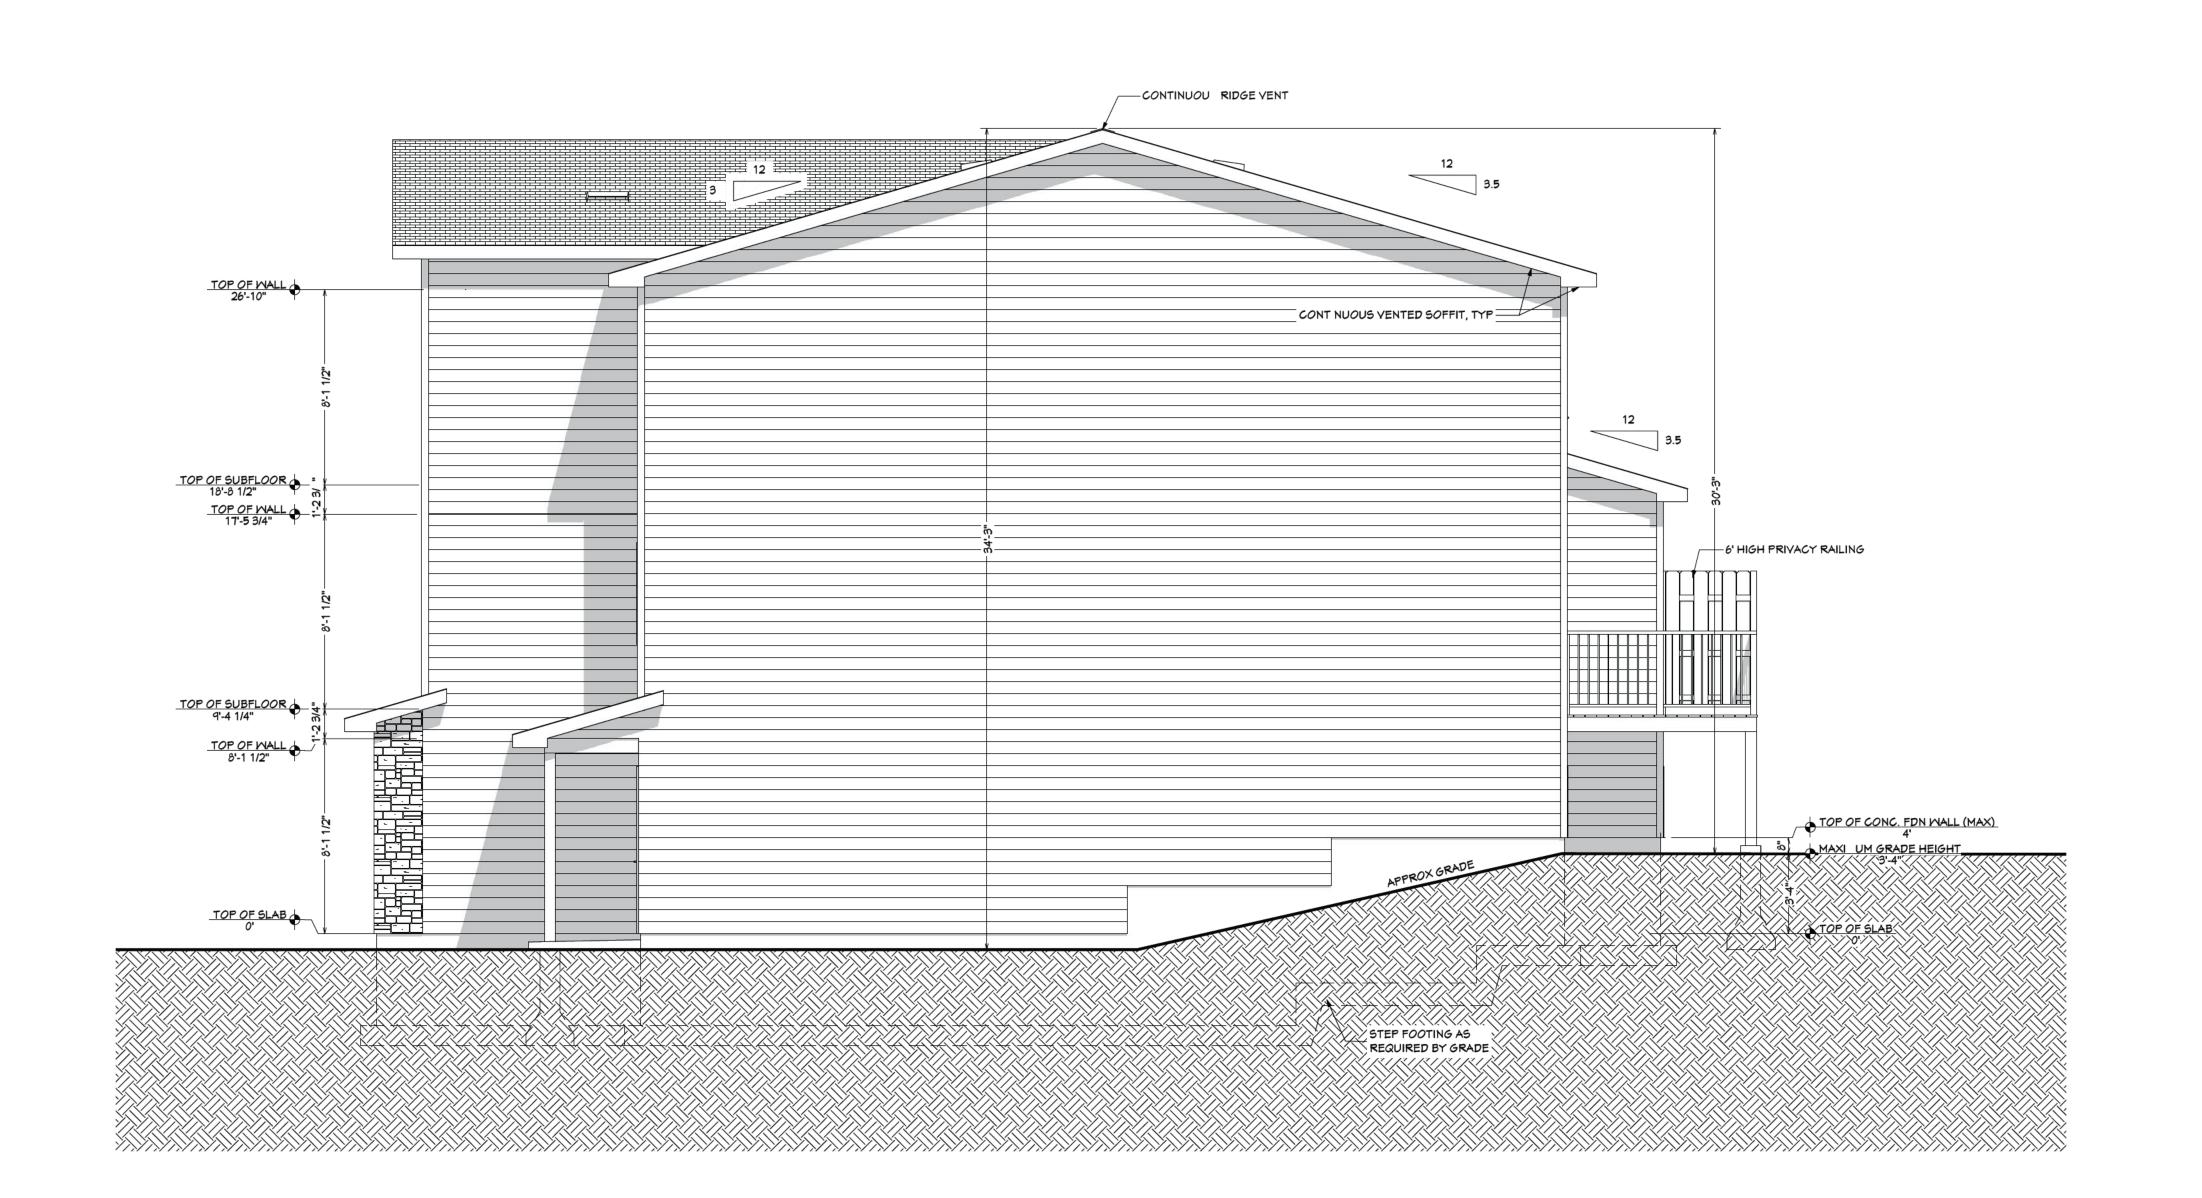

GENERAL NOTES -

1. BUILDER QUALIFICATIONS THIS PLAN IS INTENDED FOR USE BY
PERSONS KNOWLEDGEABLE IN AND FAMILIAR
WITH GENERALLY ACCEPTED METHODS,
TECHNIQUES AND STANDARDS NECESSARY
FOR THE CONSTRUCTION OF THIS
STRUCTURE.

2. BUILDING CODES –
- ALL WORK TO BE COMPLETED IN
ACCORDANCE WITH THE CURRENT NATIONAL
BUILDING CODE OF CANADA.
- ALL FEDERAL, PROVINCIAL AND LOCAL
ORDINANCES, ETC., SHALL BE CONSIDERED
AS SPECIFICATIONS FOR THIS STRUCTURE
AND SHALL TAKE PRECEDENCE OVER
ANYTHING SHOWN, DESCRIBED OR IMPLIED,
IF AND WHERE VARIANCES OCCUR.
- IN THE CASE OF HIGH SNOW LOADS OR
UNUSUAL SITE CONDITIONS. NON-STANDARD


- IN THE CASE OF HIGH SNOW LOADS OR UNUSUAL SITE CONDITIONS, NON-STANDARD FOUNDATIONS OR BEAM SIZES BEYOND THE SCOPE OF NBC PART 9 TABLES, THE OWNER / BUILDER MAY BE REQUIRED TO PROVIDE AT THEIR EXPENSE, AN ENGINEER'S REPORT. PLEASE CONSULT WITH LOCAL BUILDING AUTHORITIES.

3. ERRORS AND OMISSIONS –
GREAT CARE HAS BEEN TAKEN IN THE
PRODUCTION OF PLANS FOR THIS PROJECT,
BUT THERE ALWAYS EXISTS THE SMALL
POSSIBILITY FOR ERRORS. IT IS VERY
IMPORTANT THAT THE BUILDER CAREFULLY
REVIEW & CHECK ALL DETAILS AND
INFORMATION ON THIS PLAN INCLUDING
DIMENSIONING PRIOR TO PROCEEDING WITH
CONSTRUCTION. RESPONSIBILITY MUST LIE
WITH THE BUILDER. HOWEVER, ANY ERRORS
OR OMISSIONS FOUND SHOULD BE
REPORTED IMMEDIATELY TO B&L HOUSE
PLANS PRIOR TO CONSTRUCTION.

4. B&L HOUSE PLANS SHALL NOT BE RESPONSIBLE FOR EXISTING SITE CONDITIONS SUCH AS SOIL BEARING CAPACITY, WATER TABLE, BURIED STRUCTURES, OR PROXIMITY TO PROPERTY LINES.

5. CARBON MONOXIDE DETECTORS TO BE INSTALLED ON EACH LEVEL ADJACENT TO BEDROOMS AND WHERE PROPANE FIREPLACE, GAS AND WOOD BURNING APPLIANCES ARE USED.

6. ALL DRAWINGS REMAIN THE PROPERTY OF 'B&L HOUSE PLANS'

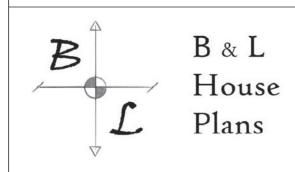

BRYDON.HUNTLEY@GMAIL.COM


PROJECT NAME -

EVERGREEN PHASE 2 4 UNIT APT BUILDING -(UNITS 1A - 4B)

DRAWING NAME -

RIGHT ELEVATION

REV#	REVISION		DATE
1	ISSUED FOR CONST.		JAN 19, 2024
2	ISSUED FO	R PERMIT	JAN 24, 2025
3	ISSUED FO	R PERMIT	APR 2, 2025
4	EGRESS WINDOWS, 5/8" DENSGLASS, ROOF VENTS		APR 16, 2025
5	MISC REVISIONS		APR 24, 2025
6	REMOVED	WET BARS	APR 28, 2025
7	ADDED 4 UNITS		AUG 14, 2025
SCALE:		SHEET:	

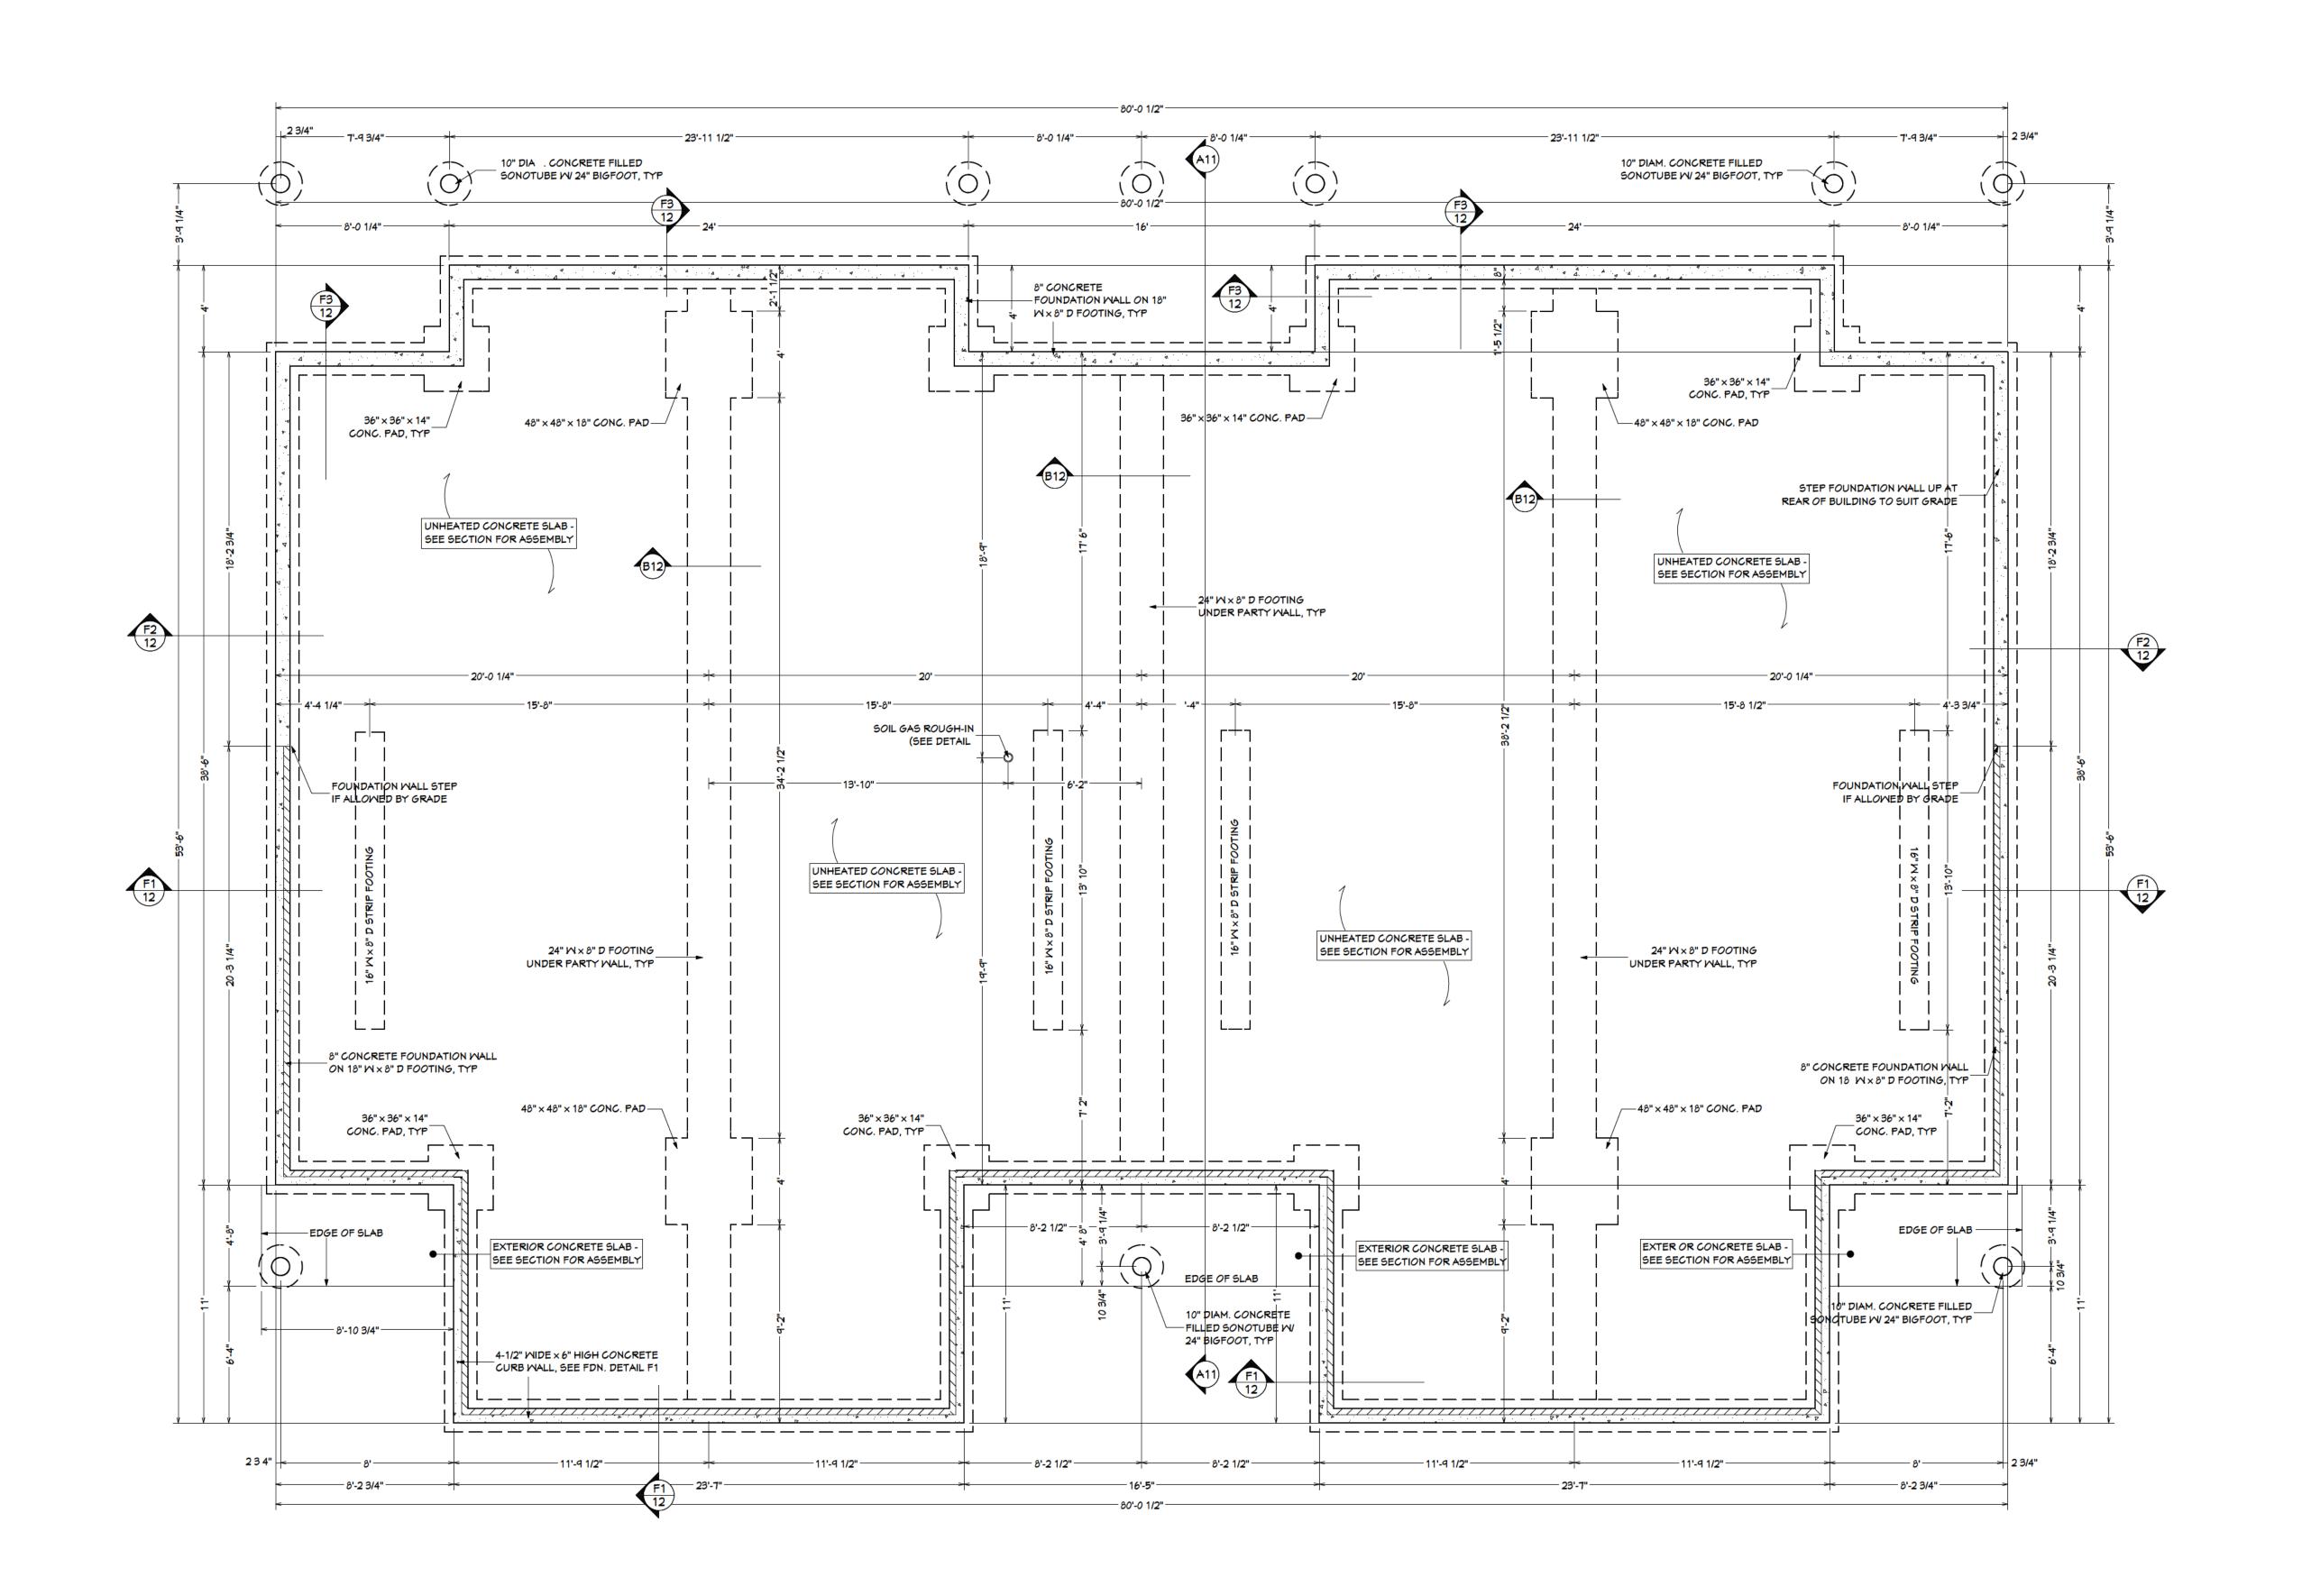

GENERAL NOTES -

1. BUILDER QUALIFICATIONS THIS PLAN IS INTENDED FOR USE BY
PERSONS KNOWLEDGEABLE IN AND FAMILIAR
WITH GENERALLY ACCEPTED METHODS,
TECHNIQUES AND STANDARDS NECESSARY
FOR THE CONSTRUCTION OF THIS
STRUCTURE.

2. BUILDING CODES –

- ALL WORK TO BE COMPLETED IN
ACCORDANCE WITH THE CURRENT NATIONAL
BUILDING CODE OF CANADA.
- ALL FEDERAL, PROVINCIAL AND LOCAL
ORDINANCES, ETC., SHALL BE CONSIDERED
AS SPECIFICATIONS FOR THIS STRUCTURE
AND SHALL TAKE PRECEDENCE OVER
ANYTHING SHOWN, DESCRIBED OR IMPLIED,


IF AND WHERE VARIANCES OCCUR.
- IN THE CASE OF HIGH SNOW LOADS OR
UNUSUAL SITE CONDITIONS, NON-STANDARD
FOUNDATIONS OR BEAM SIZES BEYOND THE
SCOPE OF NBC PART 9 TABLES, THE OWNER /
BUILDER MAY BE REQUIRED TO PROVIDE AT
THEIR EXPENSE, AN ENGINEER'S REPORT.
PLEASE CONSULT WITH LOCAL BUILDING
AUTHORITIES.

3. ERRORS AND OMISSIONS –
GREAT CARE HAS BEEN TAKEN IN THE
PRODUCTION OF PLANS FOR THIS PROJECT,
BUT THERE ALWAYS EXISTS THE SMALL
POSSIBILITY FOR ERRORS. IT IS VERY
IMPORTANT THAT THE BUILDER CAREFULLY
REVIEW & CHECK ALL DETAILS AND
INFORMATION ON THIS PLAN INCLUDING
DIMENSIONING PRIOR TO PROCEEDING WITH
CONSTRUCTION. RESPONSIBILITY MUST LIE
WITH THE BUILDER. HOWEVER, ANY ERRORS
OR OMISSIONS FOUND SHOULD BE
REPORTED IMMEDIATELY TO B&L HOUSE
PLANS PRIOR TO CONSTRUCTION.

4. B&L HOUSE PLANS SHALL NOT BE RESPONSIBLE FOR EXISTING SITE CONDITIONS SUCH AS SOIL BEARING CAPACITY, WATER TABLE, BURIED STRUCTURES, OR PROXIMITY TO PROPERTY LINES.

5. CARBON MONOXIDE DETECTORS TO BE INSTALLED ON EACH LEVEL ADJACENT TO BEDROOMS AND WHERE PROPANE FIREPLACE, GAS AND WOOD BURNING APPLIANCES ARE USED.

6. ALL DRAWINGS REMAIN THE PROPERTY OF 'B&L HOUSE PLANS'

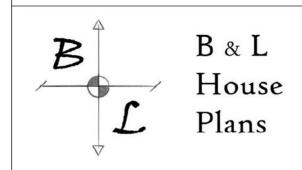

BRYDON.HUNTLEY@GMAIL.COM


PROJECT NAME -

EVERGREEN PHASE 2 4 UNIT APT BUILDING -(UNITS 1A - 4B)

DRAWING NAME -

FOUNDATION

REVIS	ION TABLE -		
REV#	REV	/ISION	DATE
1	ISSUED F	OR CONST.	JAN 19, 2024
2	ISSUED FOR PERMIT		JAN 24, 2025
3	ISSUED FOR PERMIT		APR 2, 2025
4	EGRESS WINDOWS, 5/8" DENSGLASS, ROOF VENTS		APR 16, 2025
5	MISC RE	VISIONS	APR 24, 2025
6	REMOVED WET BARS		APR 28, 2025
7	ADDED 4	UNITS	AUG 14, 2025
SCALI	≣:	SHEET:	
1/4" = 1'		PAGE 7 (OF 12

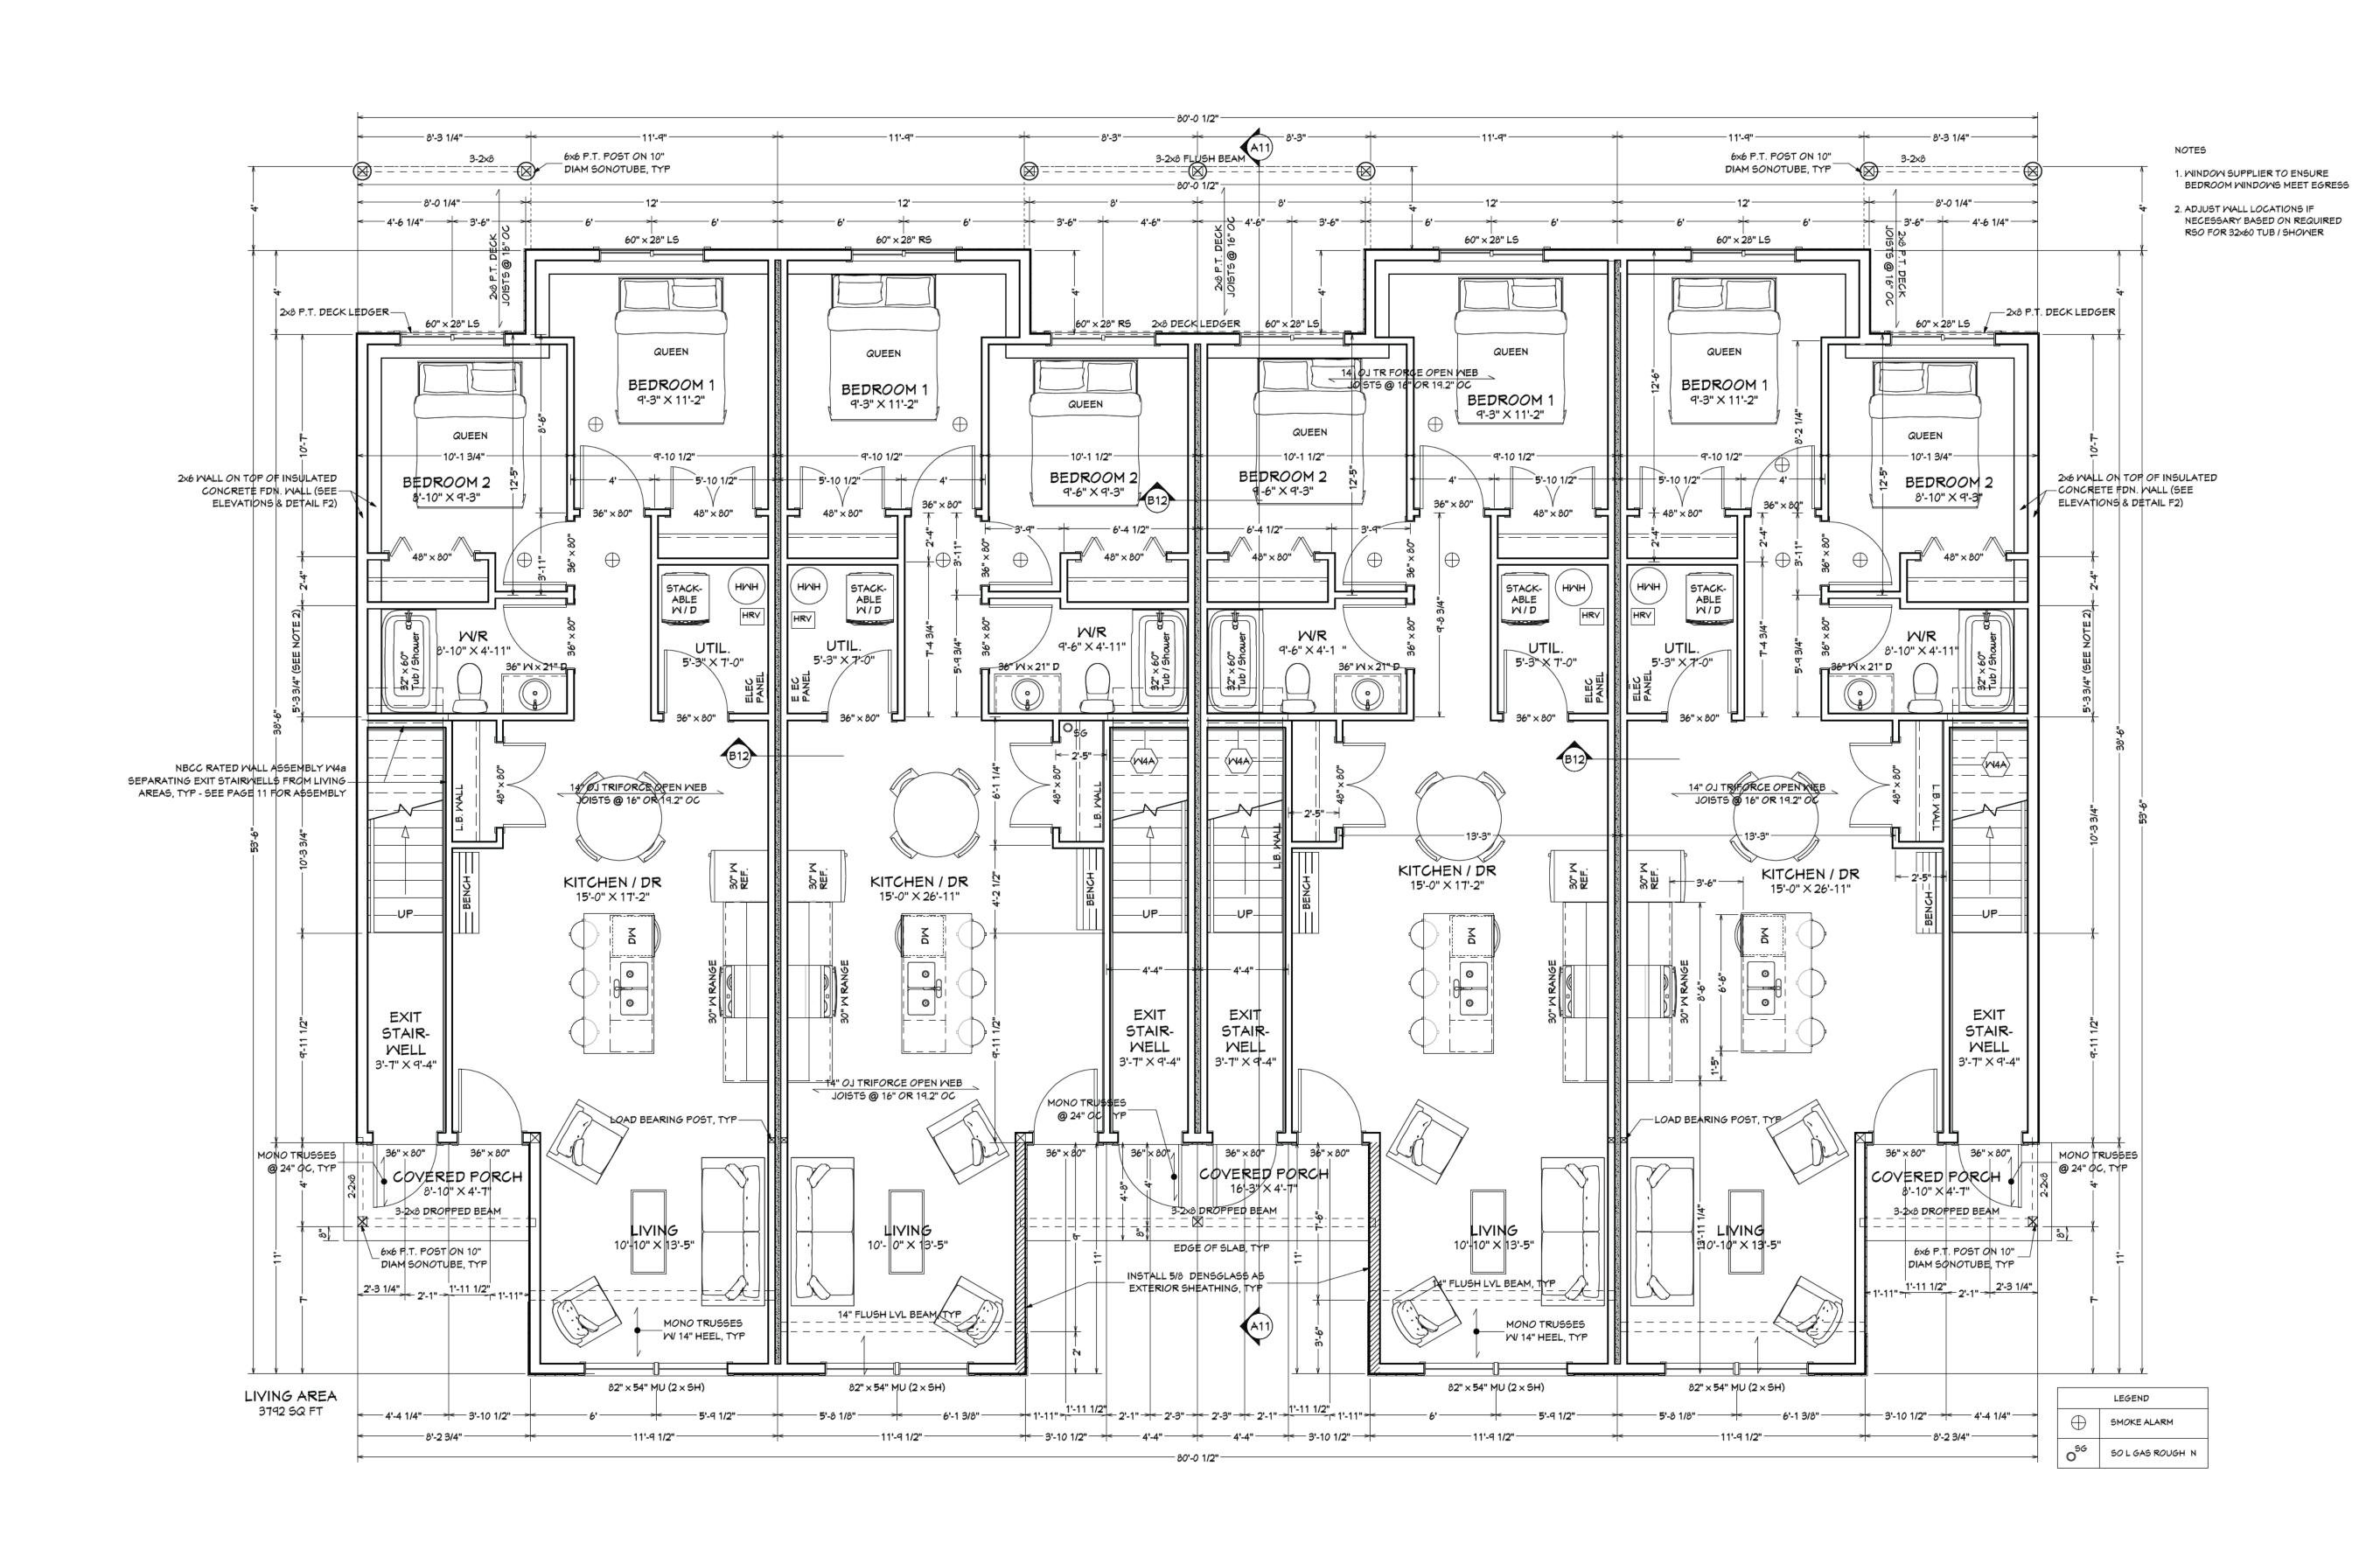

GENERAL NOTES -

1. BUILDER QUALIFICATIONS THIS PLAN IS INTENDED FOR USE BY
PERSONS KNOWLEDGEABLE IN AND FAMILIAR
WITH GENERALLY ACCEPTED METHODS,
TECHNIQUES AND STANDARDS NECESSARY
FOR THE CONSTRUCTION OF THIS
STRUCTURE.

2. BUILDING CODES –
- ALL WORK TO BE COMPLETED IN
ACCORDANCE WITH THE CURRENT NATIONAL
BUILDING CODE OF CANADA.
- ALL FEDERAL, PROVINCIAL AND LOCAL
ORDINANCES, ETC., SHALL BE CONSIDERED
AS SPECIFICATIONS FOR THIS STRUCTURE
AND SHALL TAKE PRECEDENCE OVER
ANYTHING SHOWN, DESCRIBED OR IMPLIED,
IF AND WHERE VARIANCES OCCUR.
- IN THE CASE OF HIGH SNOW LOADS OR


UNUSUAL SITE CONDITIONS, NON-STANDARD FOUNDATIONS OR BEAM SIZES BEYOND THE SCOPE OF NBC PART 9 TABLES, THE OWNER / BUILDER MAY BE REQUIRED TO PROVIDE AT THEIR EXPENSE, AN ENGINEER'S REPORT. PLEASE CONSULT WITH LOCAL BUILDING AUTHORITIES.

3. ERRORS AND OMISSIONS –
GREAT CARE HAS BEEN TAKEN IN THE
PRODUCTION OF PLANS FOR THIS PROJECT,
BUT THERE ALWAYS EXISTS THE SMALL
POSSIBILITY FOR ERRORS. IT IS VERY
IMPORTANT THAT THE BUILDER CAREFULLY
REVIEW & CHECK ALL DETAILS AND
INFORMATION ON THIS PLAN INCLUDING
DIMENSIONING PRIOR TO PROCEEDING WITH
CONSTRUCTION. RESPONSIBILITY MUST LIE
WITH THE BUILDER. HOWEVER, ANY ERRORS
OR OMISSIONS FOUND SHOULD BE
REPORTED IMMEDIATELY TO B&L HOUSE
PLANS PRIOR TO CONSTRUCTION.

4. B&L HOUSE PLANS SHALL NOT BE RESPONSIBLE FOR EXISTING SITE CONDITIONS SUCH AS SOIL BEARING CAPACITY, WATER TABLE, BURIED STRUCTURES, OR PROXIMITY TO PROPERTY LINES.

5. CARBON MONOXIDE DETECTORS TO BE INSTALLED ON EACH LEVEL ADJACENT TO BEDROOMS AND WHERE PROPANE FIREPLACE, GAS AND WOOD BURNING APPLIANCES ARE USED.

6. ALL DRAWINGS REMAIN THE PROPERTY OF 'B&L HOUSE PLANS'

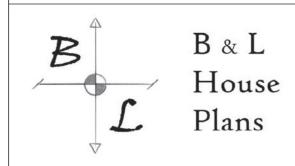

BRYDON.HUNTLEY@GMAIL.COM


PROJECT NAME -

EVERGREEN PHASE 2 4 UNIT APT BUILDING -(UNITS 1A - 4B)

DRAWING NAME -

MAIN FLOOR

REV#	REVISION		DATE
1	ISSUED FO	OR CONST.	JAN 19, 202
2	ISSUED FO	OR PERMIT	JAN 24, 202
3	ISSUED FO	OR PERMIT	APR 2, 2025
4	EGRESS V 5/8" DENS ROOF VE		APR 16, 202
5	MISC REVISIONS		APR 24, 202
6	REMOVED WET BARS		APR 28, 202
7	ADDED 4 UNITS		AUG 14, 202
SCALE	≣:	SHEET:	
1/4"	= 1'	PAGE 8 (DF 12

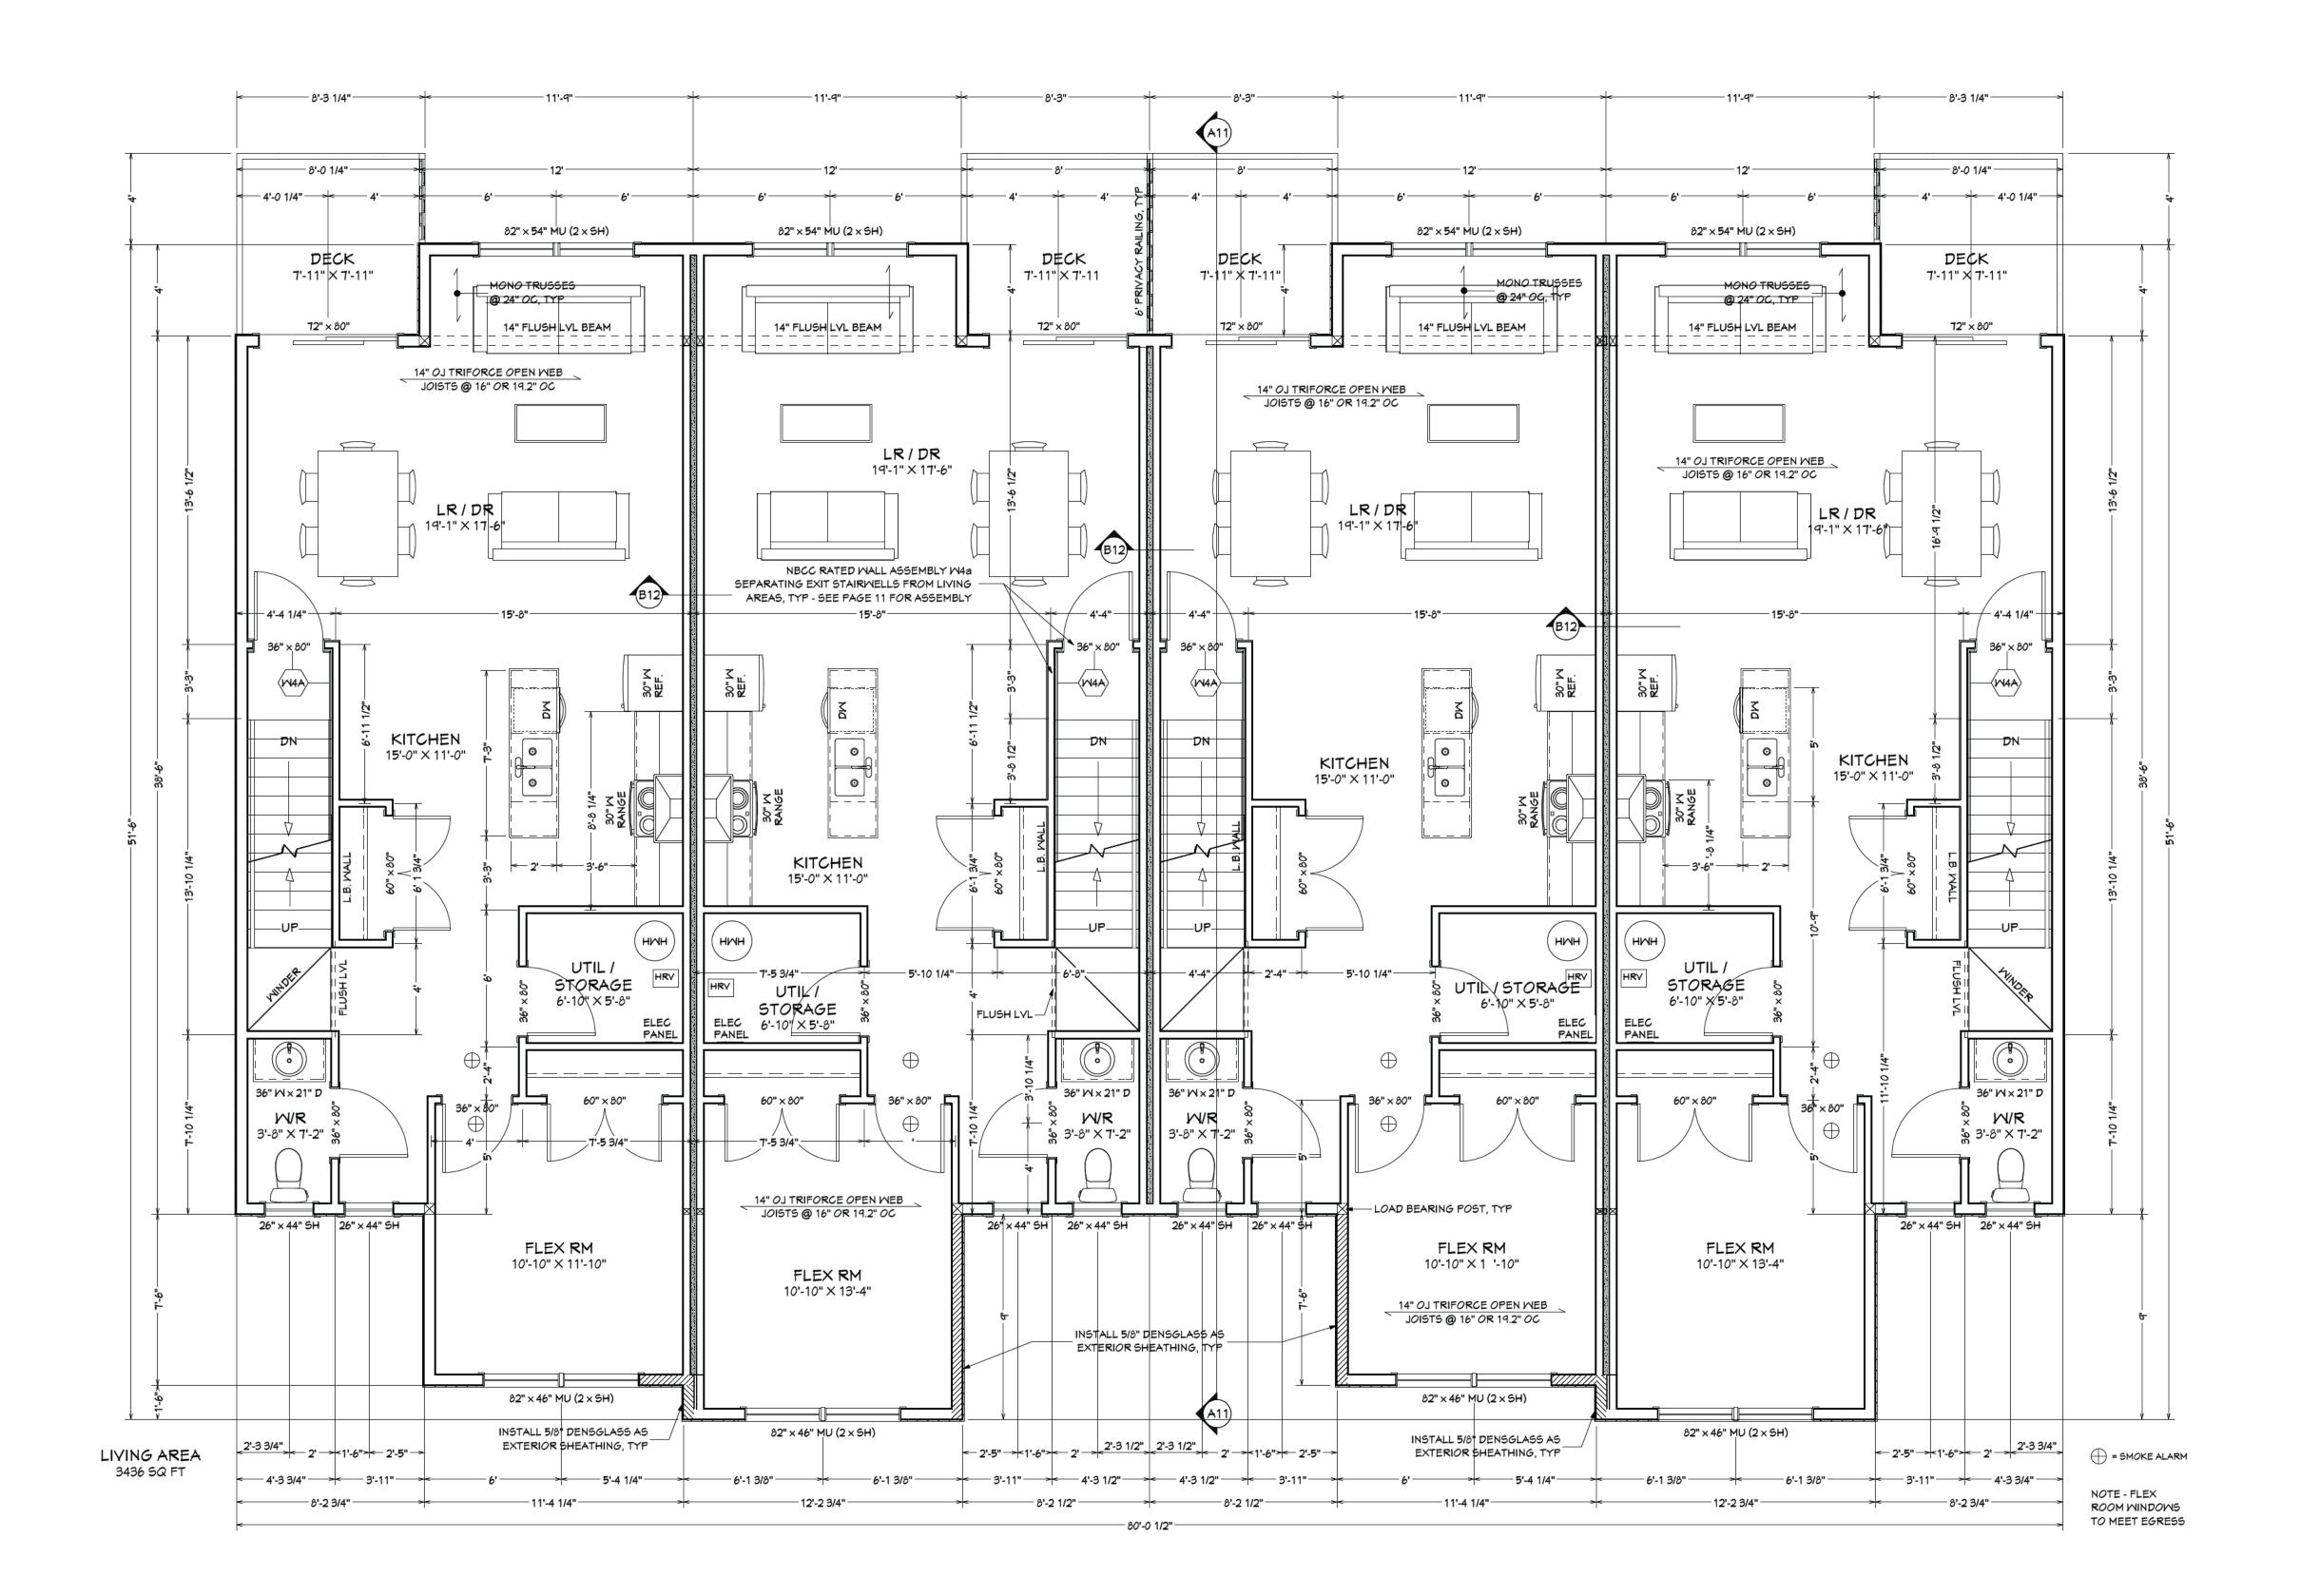

GENERAL NOTES -

1. BUILDER QUALIFICATIONS THIS PLAN IS INTENDED FOR USE BY
PERSONS KNOWLEDGEABLE IN AND FAMILIAR
WITH GENERALLY ACCEPTED METHODS,
TECHNIQUES AND STANDARDS NECESSARY
FOR THE CONSTRUCTION OF THIS
STRUCTURE.

2. BUILDING CODES -

- ALL WORK TO BE COMPLETED IN
ACCORDANCE WITH THE CURRENT NATIONAL
BUILDING CODE OF CANADA.
- ALL FEDERAL, PROVINCIAL AND LOCAL
ORDINANCES, ETC., SHALL BE CONSIDERED
AS SPECIFICATIONS FOR THIS STRUCTURE
AND SHALL TAKE PRECEDENCE OVER
ANYTHING SHOWN, DESCRIBED OR IMPLIED,


IF AND WHERE VARIANCES OCCUR.
- IN THE CASE OF HIGH SNOW LOADS OR
UNUSUAL SITE CONDITIONS, NON-STANDARD
FOUNDATIONS OR BEAM SIZES BEYOND THE
SCOPE OF NBC PART 9 TABLES, THE OWNER /
BUILDER MAY BE REQUIRED TO PROVIDE AT
THEIR EXPENSE, AN ENGINEER'S REPORT.
PLEASE CONSULT WITH LOCAL BUILDING
AUTHORITIES.

3. ERRORS AND OMISSIONS –
GREAT CARE HAS BEEN TAKEN IN THE
PRODUCTION OF PLANS FOR THIS PROJECT,
BUT THERE ALWAYS EXISTS THE SMALL
POSSIBILITY FOR ERRORS. IT IS VERY
IMPORTANT THAT THE BUILDER CAREFULLY
REVIEW & CHECK ALL DETAILS AND
INFORMATION ON THIS PLAN INCLUDING
DIMENSIONING PRIOR TO PROCEEDING WITH
CONSTRUCTION. RESPONSIBILITY MUST LIE
WITH THE BUILDER. HOWEVER, ANY ERRORS
OR OMISSIONS FOUND SHOULD BE
REPORTED IMMEDIATELY TO B&L HOUSE
PLANS PRIOR TO CONSTRUCTION.

4. B&L HOUSE PLANS SHALL NOT BE RESPONSIBLE FOR EXISTING SITE CONDITIONS SUCH AS SOIL BEARING CAPACITY, WATER TABLE, BURIED STRUCTURES, OR PROXIMITY TO PROPERTY LINES.

5. CARBON MONOXIDE DETECTORS TO BE INSTALLED ON EACH LEVEL ADJACENT TO BEDROOMS AND WHERE PROPANE FIREPLACE, GAS AND WOOD BURNING APPLIANCES ARE USED.

6. ALL DRAWINGS REMAIN THE PROPERTY OF 'B&L HOUSE PLANS'

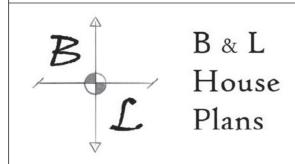

BRYDON.HUNTLEY@GMAIL.COM


PROJECT NAME -

EVERGREEN PHASE 2 4 UNIT APT BUILDING -(UNITS 1A - 4B)

DRAWING NAME -

SECOND FLOOR

REV#	RE\	/ISION	DATE
1	ISSUED F	OR CONST.	JAN 19, 20
2	ISSUED F	OR PERMIT	JAN 24, 20
3	ISSUED F	OR PERMIT	APR 2, 202
4	EGRESS WINDOWS, 5/8" DENSGLASS, ROOF VENTS		APR 16, 20
5	MISC REVISIONS		APR 24, 20
6	REMOVED WET BARS		APR 28, 20
7	ADDED 4 UNITS		AUG 14, 20
SCALE:		SHEET:	
1/4"		PAGE 9 (

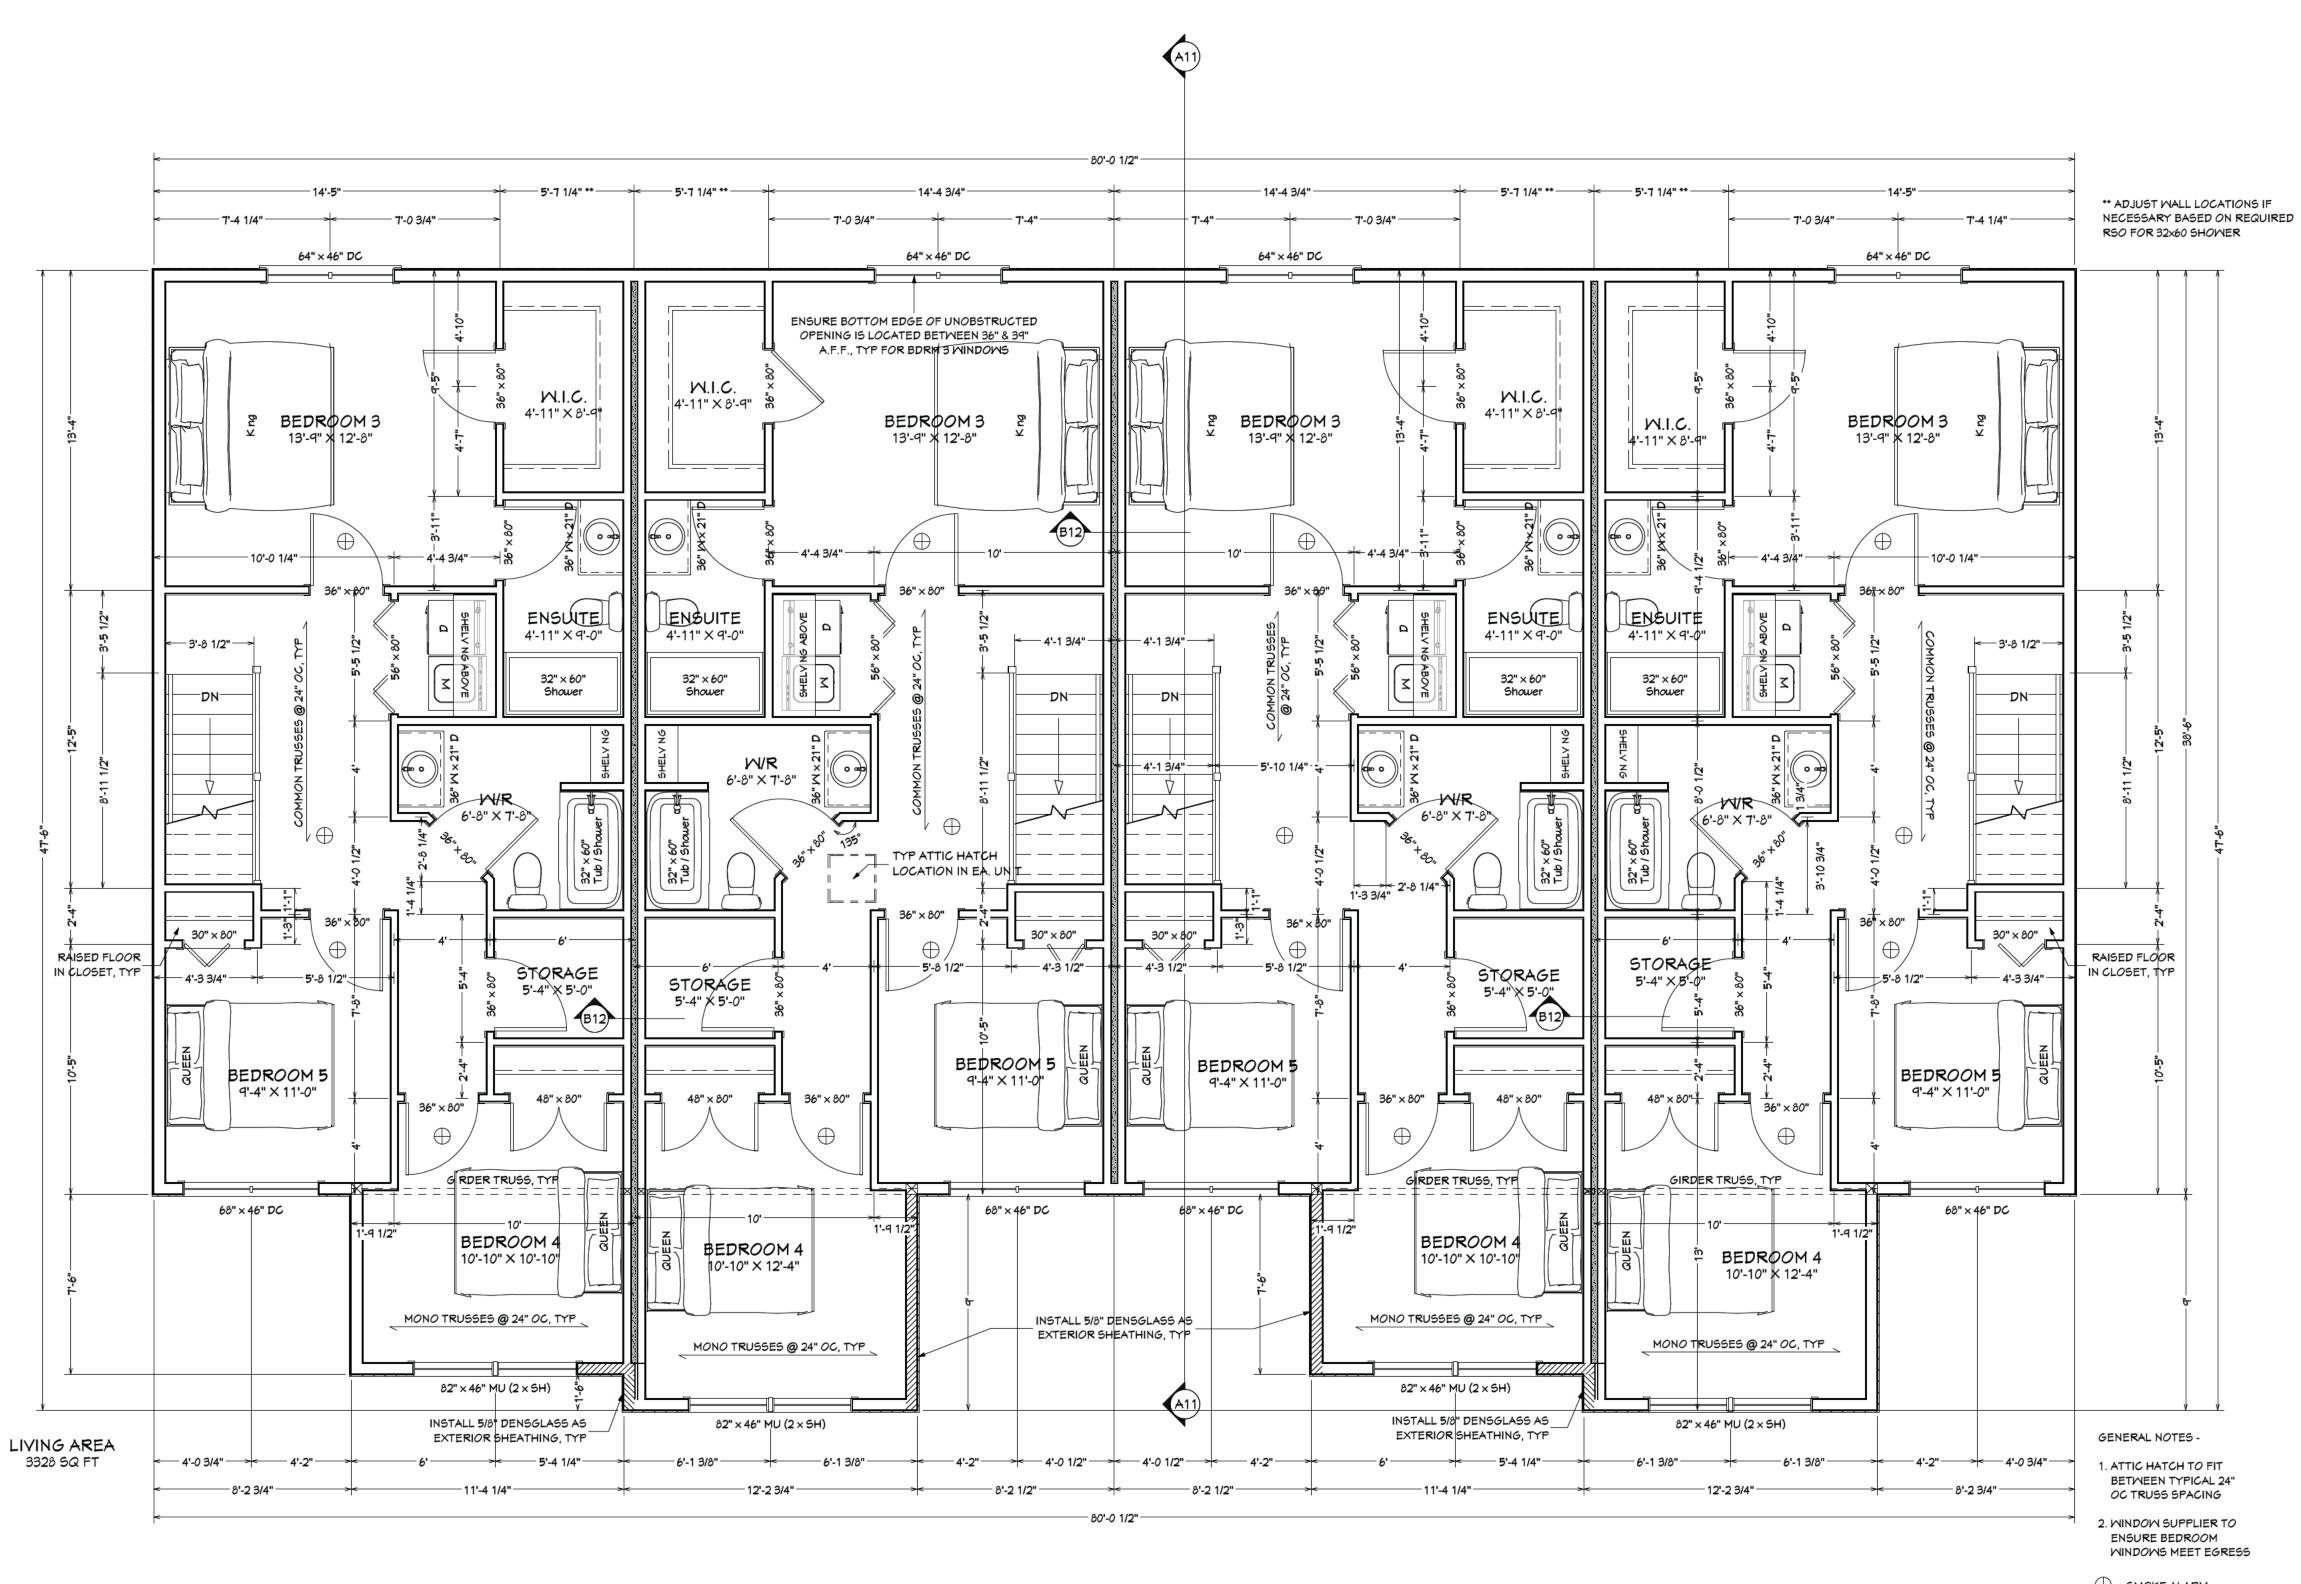

= SMOKE ALARM

GENERAL NOTES -

1. BUILDER QUALIFICATIONS THIS PLAN IS INTENDED FOR USE BY
PERSONS KNOWLEDGEABLE IN AND FAMILIAR
WITH GENERALLY ACCEPTED METHODS,
TECHNIQUES AND STANDARDS NECESSARY
FOR THE CONSTRUCTION OF THIS

STRUCTURE.

2. BUILDING CODES –
- ALL WORK TO BE COMPLETED IN
ACCORDANCE WITH THE CURRENT NATIONAL
BUILDING CODE OF CANADA.
- ALL FEDERAL, PROVINCIAL AND LOCAL
ORDINANCES, ETC., SHALL BE CONSIDERED
AS SPECIFICATIONS FOR THIS STRUCTURE
AND SHALL TAKE PRECEDENCE OVER

ANYTHING SHOWN, DESCRIBED OR IMPLIED, IF AND WHERE VARIANCES OCCUR.


- IN THE CASE OF HIGH SNOW LOADS OR UNUSUAL SITE CONDITIONS, NON-STANDARD FOUNDATIONS OR BEAM SIZES BEYOND THE SCOPE OF NBC PART 9 TABLES, THE OWNER / BUILDER MAY BE REQUIRED TO PROVIDE AT THEIR EXPENSE, AN ENGINEER'S REPORT. PLEASE CONSULT WITH LOCAL BUILDING AUTHORITIES.

3. ERRORS AND OMISSIONS –
GREAT CARE HAS BEEN TAKEN IN THE
PRODUCTION OF PLANS FOR THIS PROJECT,
BUT THERE ALWAYS EXISTS THE SMALL
POSSIBILITY FOR ERRORS. IT IS VERY
IMPORTANT THAT THE BUILDER CAREFULLY
REVIEW & CHECK ALL DETAILS AND
INFORMATION ON THIS PLAN INCLUDING
DIMENSIONING PRIOR TO PROCEEDING WITH
CONSTRUCTION. RESPONSIBILITY MUST LIE
WITH THE BUILDER. HOWEVER, ANY ERRORS
OR OMISSIONS FOUND SHOULD BE
REPORTED IMMEDIATELY TO B&L HOUSE
PLANS PRIOR TO CONSTRUCTION.

4. B&L HOUSE PLANS SHALL NOT BE RESPONSIBLE FOR EXISTING SITE CONDITIONS SUCH AS SOIL BEARING CAPACITY, WATER TABLE, BURIED STRUCTURES, OR PROXIMITY TO PROPERTY LINES.

5. CARBON MONOXIDE DETECTORS TO BE INSTALLED ON EACH LEVEL ADJACENT TO BEDROOMS AND WHERE PROPANE FIREPLACE, GAS AND WOOD BURNING APPLIANCES ARE USED.

6. ALL DRAWINGS REMAIN THE PROPERTY OF 'B&L HOUSE PLANS'

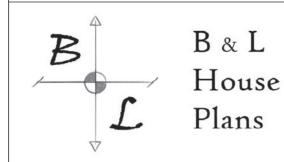

BRYDON.HUNTLEY@GMAIL.COM


PROJECT NAME -

EVERGREEN PHASE 2 4 UNIT APT BUILDING -(UNITS 1A - 4B)

DRAWING NAME -

THIRD FLOOR

REV#	REVISION		DATE
1	ISSUED FOR CONST.		JAN 19, 20
2	ISSUED FOI	ISSUED FOR PERMIT	
3	ISSUED FOI	R PERMIT	APR 2, 202
4	EGRESS WI 5/8" DENSG ROOF VENT	LASS,	APR 16, 20
5	MISC REVISIONS		APR 24, 20
6	REMOVED	WET BARS	APR 28, 20
7	ADDED 4 UNITS		AUG 14, 20
SCAL	E: \$	SHEET:	

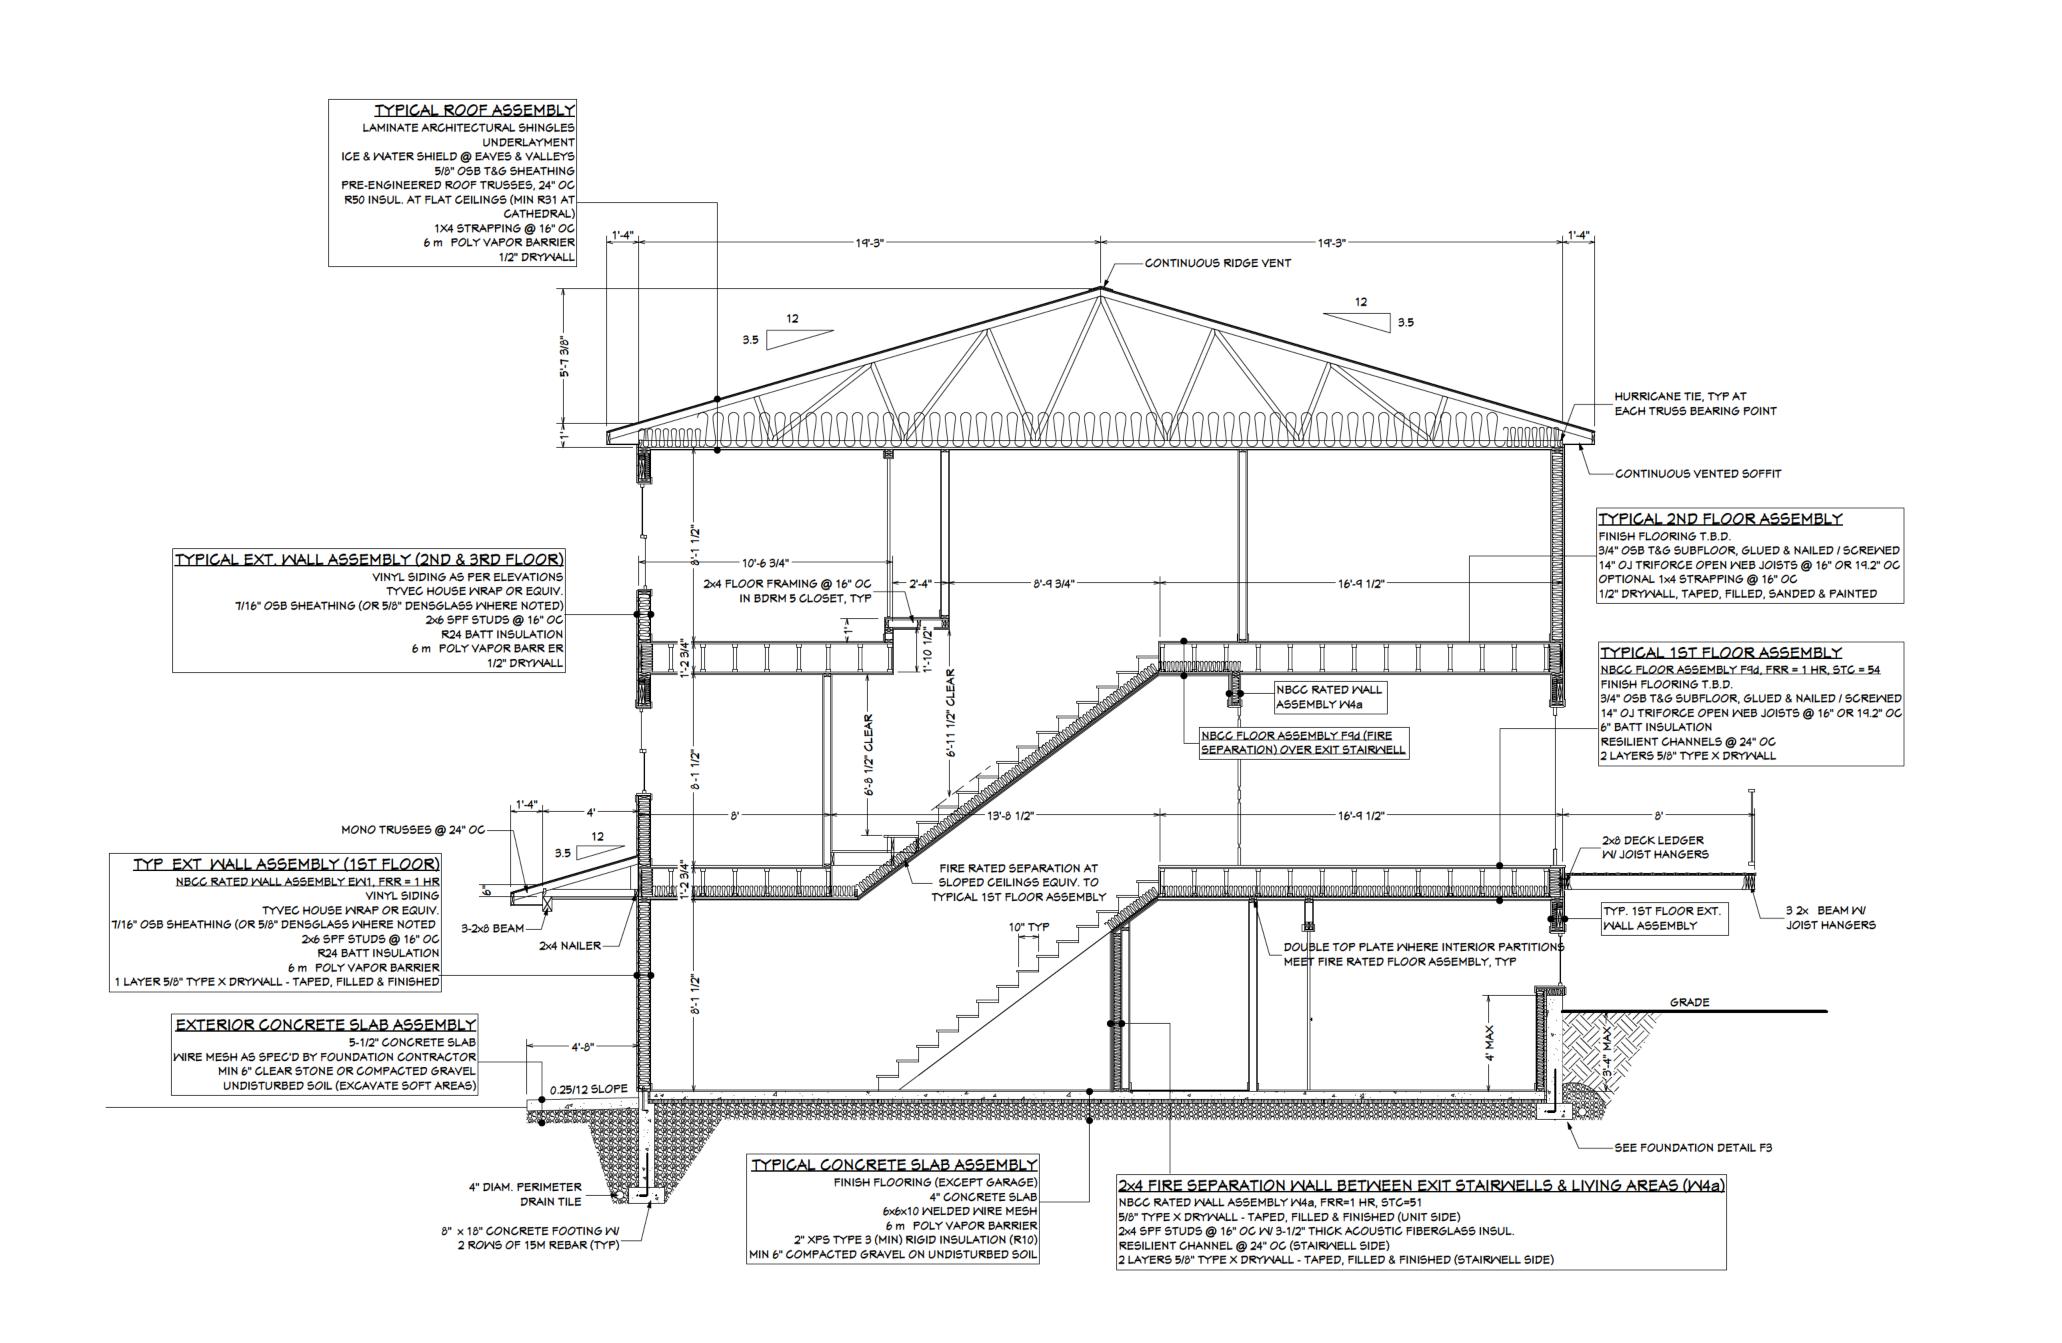

GENERAL NOTES -

1. BUILDER QUALIFICATIONS THIS PLAN IS INTENDED FOR USE BY
PERSONS KNOWLEDGEABLE IN AND FAMILIAR
WITH GENERALLY ACCEPTED METHODS,
TECHNIQUES AND STANDARDS NECESSARY
FOR THE CONSTRUCTION OF THIS
STRUCTURE.

2. BUILDING CODES –
- ALL WORK TO BE COMPLETED IN
ACCORDANCE WITH THE CURRENT NATIONAL
BUILDING CODE OF CANADA.
- ALL FEDERAL, PROVINCIAL AND LOCAL
ORDINANCES, ETC., SHALL BE CONSIDERED

AS SPECIFICATIONS FOR THIS STRUCTURE AND SHALL TAKE PRECEDENCE OVER

ANYTHING SHOWN, DESCRIBED OR IMPLIED, IF AND WHERE VARIANCES OCCUR.


- IN THE CASE OF HIGH SNOW LOADS OR UNUSUAL SITE CONDITIONS, NON-STANDARD FOUNDATIONS OR BEAM SIZES BEYOND THE SCOPE OF NBC PART 9 TABLES, THE OWNER / BUILDER MAY BE REQUIRED TO PROVIDE AT THEIR EXPENSE, AN ENGINEER'S REPORT. PLEASE CONSULT WITH LOCAL BUILDING AUTHORITIES.

3. ERRORS AND OMISSIONS –
GREAT CARE HAS BEEN TAKEN IN THE
PRODUCTION OF PLANS FOR THIS PROJECT,
BUT THERE ALWAYS EXISTS THE SMALL
POSSIBILITY FOR ERRORS. IT IS VERY
IMPORTANT THAT THE BUILDER CAREFULLY
REVIEW & CHECK ALL DETAILS AND
INFORMATION ON THIS PLAN INCLUDING
DIMENSIONING PRIOR TO PROCEEDING WITH
CONSTRUCTION. RESPONSIBILITY MUST LIE
WITH THE BUILDER. HOWEVER, ANY ERRORS
OR OMISSIONS FOUND SHOULD BE
REPORTED IMMEDIATELY TO B&L HOUSE
PLANS PRIOR TO CONSTRUCTION.

4. B&L HOUSE PLANS SHALL NOT BE RESPONSIBLE FOR EXISTING SITE CONDITIONS SUCH AS SOIL BEARING CAPACITY, WATER TABLE, BURIED STRUCTURES, OR PROXIMITY TO PROPERTY LINES.

5. CARBON MONOXIDE DETECTORS TO BE INSTALLED ON EACH LEVEL ADJACENT TO BEDROOMS AND WHERE PROPANE FIREPLACE, GAS AND WOOD BURNING APPLIANCES ARE USED.

6. ALL DRAWINGS REMAIN THE PROPERTY OF 'B&L HOUSE PLANS'

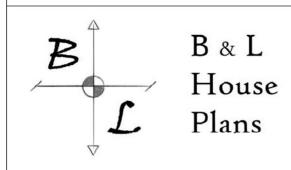

BRYDON.HUNTLEY@GMAIL.COM

PROJECT NAME -

EVERGREEN PHASE 2 4 UNIT APT BUILDING -(UNITS 1A - 4B)

DRAWING NAME -

SECTION A11

REVISION TABLE -					
REV#	REVISION		DATE		
1	ISSUED FOR CONST.		JAN 19, 2024		
2	ISSUED FOR PERMIT		JAN 24, 2025		
3	ISSUED FOR PERMIT		APR 2, 2025		
4	EGRESS WINDOWS, 5/8" DENSGLASS, ROOF VENTS		APR 16, 2025		
5	MISC REVISIONS		APR 24, 2025		
6	REMOVED WET BARS		APR 28, 2025		
7	ADDED 4 UNITS		AUG 14, 2025		
SCALE:		SHEET:			
1/4'' = 1'		PAGE 11	OF 12		


FOUNDATION DETAIL F1 - TYP. FOUNDATION WALL SCALE: 1/2" = 1'-0"

PROJECT NOTES -


- 1. FIRE SEPARATION PENETRATIONS MUST BE SEALED, TIGHTLY FITTED, FIRE STOPPED OR CONFIGURED TO MAINTAIN THE INTEGRITY OF THE SEPARATION AS PER NBCC 2015, SECTION 9.10.9.6 & 9.10.9.7
- STAIRWELL HANDRAILS REQUIRE 12" HORIZONTAL PROJECTION BEYOND LAST TREAD ONE ONE SIDE OF STAIRS
- 3. PLACEMENT OF PLUMBING FIXTURES IN THE MECHANICAL ROOM MUST MEET APPLICABLE ELECTRICAL CODE & STANDARDS
- 4. SMOKE ALARMS TO CONFORM TO NBCC SUBSECTION 9.10.19

ADAPTABILITY NOTES -

- 1. MAIN UNIT ENTRANCE DOORS SHALL BE EASILY ACCESSED AND BE CAPABLE OF BEING MADE BARRIER FREE FROM PARKING AREA OR SIDEWALK IN ORDER TO COMPLY WITH ADAPTABLE HOUSING REQUIREMENTS
- 2. ALL UNITS TO COMPLY WITH <u>ADAPTABLE HOUSING</u>
 <u>REQUIREMENTS</u> (AHR)
- 3. ALL UNIT ENTRANCE DOORS SHALL BE LOW THRESHOLD (MAX 1/2")
 & BE EQUIPPED WITH HARDWARE CONFORMING TO AHR
- 4. ALL UNIT INTERIOR DOORS SHALL BE EQUIPPED WITH DOOR OPENING HARDWARE CONFORMING TO AHR
- 5. KITCHEN CONTROLS, PLUMBING & ELECTRICAL TO CONFORM
- 6. BATHROOM CONTROLS & HARDWARE SHALL CONFORM TO AHR
- 7. WALL ASSEMBLIES ENCLOSING BATHROOM TO INCLUDE REINFORCEMENT TO ALLOW FUTURE INSTALLATION OF GRAB BARS CONFORMING TO AHR

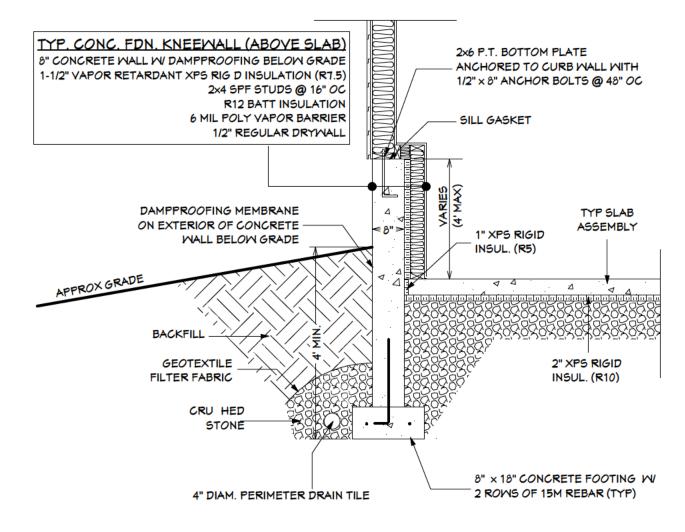


FOUNDATION DETAIL F2 CONCRETE KNEEWALL SCALE: 1/2" = 1'-0"

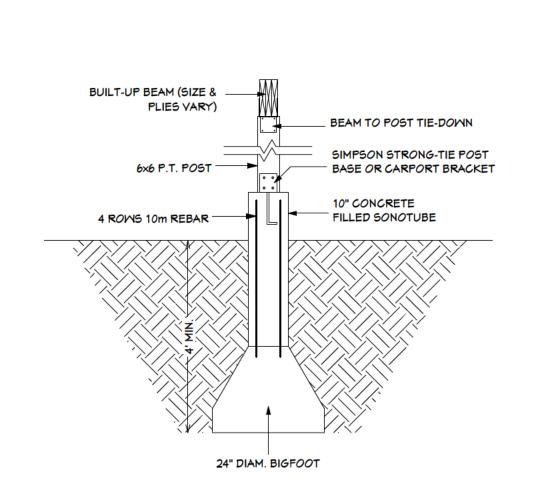


TYPICAL SONOTUBE / BEAM DETAIL

SCALE: 1/2" = 1'-0"

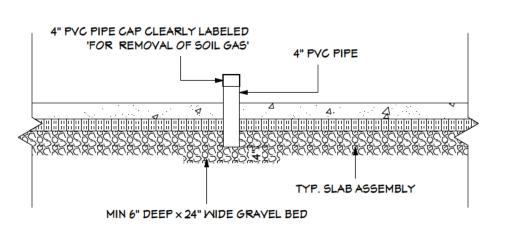


SOIL GAS ROUGH-IN DETAIL

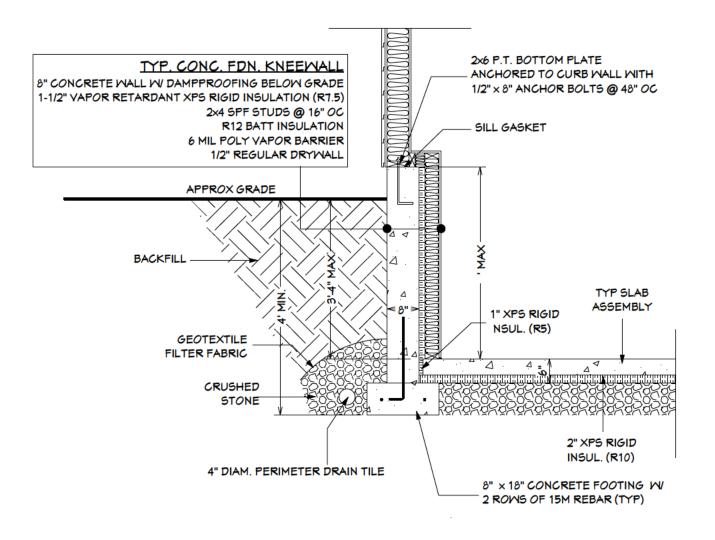

FOUNDATION DETAIL F3 -CONCRETE KNEEWALL

SCALE: 1/2" = 1'-0"

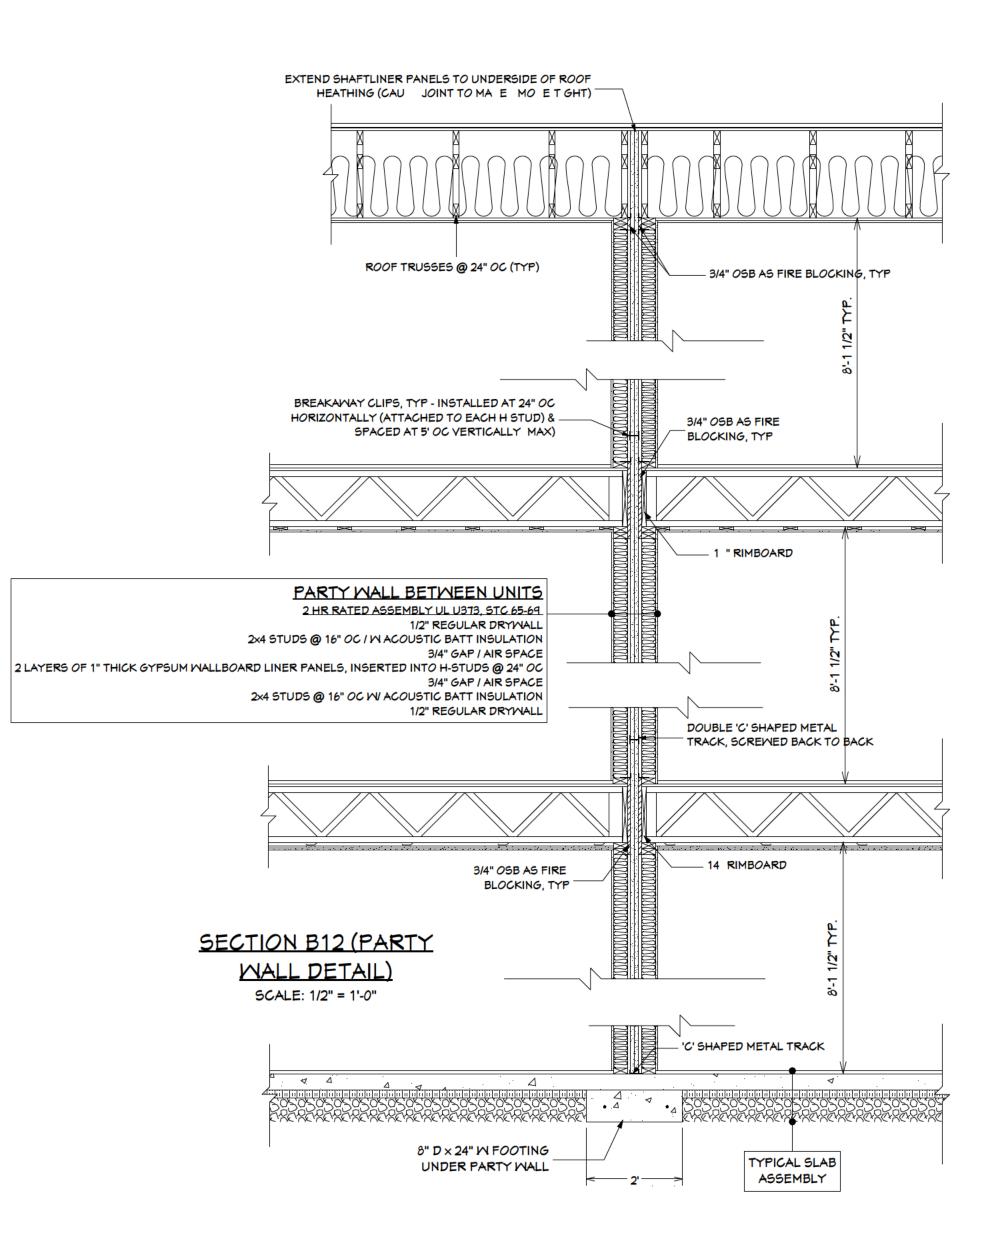

2. BUILDING CODES – - ALL WORK TO BE COMPLETED IN

1. BUILDER QUALIFICATIONS THIS PLAN IS INTENDED FOR USE BY
PERSONS KNOWLEDGEABLE IN AND FAMILIAR
WITH GENERALLY ACCEPTED METHODS,
TECHNIQUES AND STANDARDS NECESSARY
FOR THE CONSTRUCTION OF THIS
STRUCTURE.

GENERAL NOTES -

ACCORDANCE WITH THE CURRENT NATIONAL BUILDING CODE OF CANADA.

- ALL FEDERAL, PROVINCIAL AND LOCAL ORDINANCES, ETC., SHALL BE CONSIDERED AS SPECIFICATIONS FOR THIS STRUCTURE AND SHALL TAKE PRECEDENCE OVER ANYTHING SHOWN, DESCRIBED OR IMPLIED.


IF AND WHERE VARIANCES OCCUR.
- IN THE CASE OF HIGH SNOW LOADS OR
UNUSUAL SITE CONDITIONS, NON-STANDARD
FOUNDATIONS OR BEAM SIZES BEYOND THE
SCOPE OF NBC PART 9 TABLES, THE OWNER /
BUILDER MAY BE REQUIRED TO PROVIDE AT
THEIR EXPENSE, AN ENGINEER'S REPORT.
PLEASE CONSULT WITH LOCAL BUILDING
AUTHORITIES.

3. ERRORS AND OMISSIONS –
GREAT CARE HAS BEEN TAKEN IN THE
PRODUCTION OF PLANS FOR THIS PROJECT,
BUT THERE ALWAYS EXISTS THE SMALL
POSSIBILITY FOR ERRORS. IT IS VERY
IMPORTANT THAT THE BUILDER CAREFULLY
REVIEW & CHECK ALL DETAILS AND
INFORMATION ON THIS PLAN INCLUDING
DIMENSIONING PRIOR TO PROCEEDING WITH
CONSTRUCTION. RESPONSIBILITY MUST LIE
WITH THE BUILDER. HOWEVER, ANY ERRORS
OR OMISSIONS FOUND SHOULD BE
REPORTED IMMEDIATELY TO B&L HOUSE
PLANS PRIOR TO CONSTRUCTION.

4. B&L HOUSE PLANS SHALL NOT BE RESPONSIBLE FOR EXISTING SITE CONDITIONS SUCH AS SOIL BEARING CAPACITY, WATER TABLE, BURIED STRUCTURES, OR PROXIMITY TO PROPERTY LINES.

5. CARBON MONOXIDE DETECTORS TO BE INSTALLED ON EACH LEVEL ADJACENT TO BEDROOMS AND WHERE PROPANE FIREPLACE, GAS AND WOOD BURNING APPLIANCES ARE USED.

6. ALL DRAWINGS REMAIN THE PROPERTY OF 'B&L HOUSE PLANS'

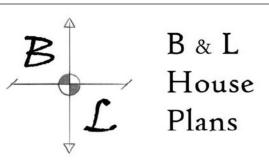

BRYDON.HUNTLEY@GMAIL.COM

PROJECT NAME -

EVERGREEN PHASE 2 4 UNIT APT BUILDING -(UNITS 1A - 4B)

DRAWING NAME -

DETAILS / SECTIONS

REVISION TABLE -						
REV#	RE	VISION	DATE			
1	ISSUED FOR CONST.		JAN 19, 2024			
2	ISSUED F	OR PERMIT	JAN 24, 2025			
3	ISSUED F	OR PERMIT	APR 2, 2025			
4	EGRESS V 5/8" DENS ROOF VE	APR 16, 2025				
5	MISC REVISIONS		APR 24, 2025			
6	REMOVED WET BARS		APR 28, 2025			
7	ADDED 4 UNITS		AUG 14, 2025			
SCAL	E :	SHEET:				
1/2"	= 1'	PAGE 12	OF 12			