

BRYDON.HUNTLEY@GMAIL.COM

GENERAL NOTES -

BUILDER QUALIFICATIONS THIS PLAN IS INTENDED FOR USE BY PERSONS
KNOWLEDGEABLE IN AND FAMILIAR WITH GENERALLY
ACCEPTED METHODS, TECHNIQUES AND STANDARDS
NECESSARY FOR THE CONSTRUCTION OF THIS
STRUCTURE.

2. BUILDING CODES –
- ALL WORK TO BE COMPLETED IN ACCORDANCE WITH THE CURRENT NATIONAL BUILDING CODE OF CANADA.

-ALL FEDERAL, PROVINCIAL AND LOCAL
ORDINANCES, ETC., SHALL BE CONSIDERED AS
SPECIFICATIONS FOR THIS STRUCTURE AND SHALL
TAKE PRECEDENCE OVER ANYTHING SHOWN,
DESCRIBED OR IMPLIED, IF AND WHERE VARIANCES
OCCUR.

OCCUR.
- IN THE CASE OF HIGH SNOW LOADS OR UNUSUAL SITE CONDITIONS, NON-STANDARD FOUNDATIONS OR BEAM SIZES BEYOND THE SCOPE OF NBC PART 9 TABLES, THE OWNER / BUILDER MAY BE REQUIRED TO PROVIDE AT THEIR EXPENSE, AN ENGINEER'S REPORT. PLEASE CONSULT WITH LOCAL BUILDING AUTHORITIES.

3. ERRORS AND OMISSIONS –
GREAT CARE HAS BEEN TAKEN IN THE
PRODUCTION OF PLANS FOR THIS PROJECT, BUT
THERE ALWAYS EXISTS THE SMALL POSSIBILITY
FOR ERRORS. IT IS VERY IMPORTANT THAT THE
BUILDER CAREFULLY REVIEW & CHECK ALL
DETAILS AND INFORMATION ON THIS PLAN
INCLUDING DIMENSIONING PRIOR TO
PROCEEDING WITH CONSTRUCTION.
RESPONSIBILITY MUST LIE WITH THE BUILDER.
HOWEVER ANY ERRORS OR OMISSIONS FOUND HOWEVER, ANY ERRORS OR OMISSIONS FOUND SHOULD BE REPORTED IMMEDIATELY TO B&L HOUSE PLANS PRIOR TO CONSTRUCTION.

B&L HOUSE PLANS SHALL NOT BE RESPONSIBLE FOR EXISTING SITE CONDITIONS SUCH AS SOIL BEARING CAPACITY, WATER TABLE, BURIED STRUCTURES, OR PROXIMITY TO PROPERTY LINES.

5. CARBON MONOXIDE DETECTORS TO BE INSTALLED ON EACH LEVEL ADJACENT TO BEDROOMS AND WHERE PROPANE FIREPLACE, GAS AND WOOD BURNING APPLIANCES ARE USED.

6. ALL DRAWINGS REMAIN THE PROPERTY OF 'B&L HOUSE PLANS'

PROJECT NAME -	REVISI	ON TABLE -	
EVERGREEN PHASE 1 10 UNIT APT BLDG (UNITS 4-8)	REV#	REVISION	DATE
TO CHIT AT I BEDG (CHITS 4-0)	16	REMOVED ROUGH-INS	FEB 5, 2025
DRAWING NAME -	17	ISSUED FOR CONST.	APR 1, 2025
3D PERSPECTIVES	18	REMOVED WET BARS	APR 28, 2025
	19	FDN. REVISIONS	JUL. 21, 2025
SCALE:	20	ADDED BASEMENT UNITS	AUG 12, 2025


SHEET:

**PAGE 1 OF 16** 

# PHASE 1 PID 00398552

LOT AREA = 27,545 SQ FT LOT COVERAGE = 8027 SQ FT (29%)

NOTE - ALL MEASUREMENTS, LOCATIONS, BOUNDARY LINES, AND SETBACKS ARE APPROXIMATE - TO BE REVIEWED AND VERIFIED BY OTHERS.

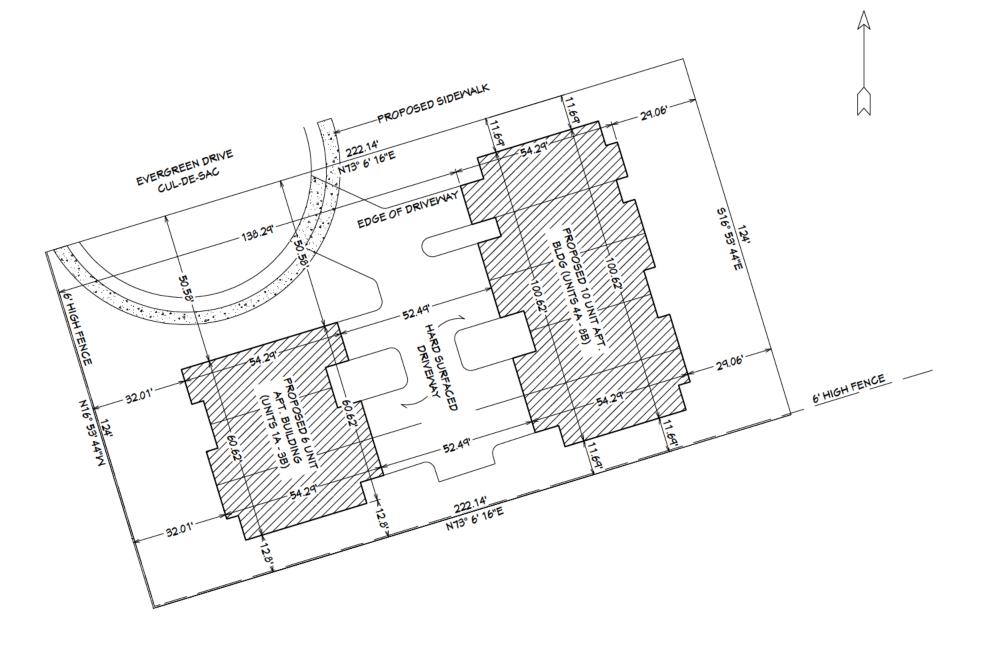



GENERAL NOTES -

BUILDER QUALIFICATIONS THIS PLAN IS INTENDED FOR USE BY PERSONS
KNOWLEDGEABLE IN AND FAMILIAR WITH GENERALLY
ACCEPTED METHODS, TECHNIQUES AND STANDARDS
NECESSARY FOR THE CONSTRUCTION OF THIS
STRUCTURE.

2. BUILDING CODES –
-ALL WORK TO BE COMPLETED IN ACCORDANCE WITH
THE CURRENT NATIONAL BUILDING CODE OF CANADA.

-ALL FEDERAL, PROVINCIAL AND LOCAL
ORDINANCES, ETC., SHALL BE CONSIDERED AS
SPECIFICATIONS FOR THIS STRUCTURE AND SHALL
TAKE PRECEDENCE OVER ANYTHING SHOWN,
DESCRIBED OR IMPLIED, IF AND WHERE VARIANCES
OCCUR.
- IN THE CASE OF HIGH SNOW LOADS OR UNUSUAL
SITE CONDITIONS NOW STANDARD EQUINIDATIONS OF

OCCUR.

IN THE CASE OF HIGH SNOW LOADS OR UNUSUAL SITE CONDITIONS, NON-STANDARD FOUNDATIONS OR BEAM SIZES BEYOND THE SCOPE OF NBC PART 9 TABLES, THE OWNER / BUILDER MAY BE REQUIRED TO PROVIDE AT THEIR EXPENSE, AN ENGINEER'S REPORT. PLEASE CONSULT WITH LOCAL BUILDING AUTHORITIES.

3. ERRORS AND OMISSIONS —
GREAT CARE HAS BEEN TAKEN IN THE
PRODUCTION OF PLANS FOR THIS PROJECT, BUT
THERE ALWAYS EXISTS THE SMALL POSSIBILITY
FOR ERRORS. IT IS VERY IMPORTANT THAT THE
BUILDER CAREFULLY REVIEW & CHECK ALL
DETAILS AND INFORMATION ON THIS PLAN
INCLUDING DIMENSIONING PRIOR TO
PROCEEDING WITH CONSTRUCTION.
RESPONSIBILITY MUST LIE WITH THE BUILDER.
HOWEVER, ANY ERRORS OR OMISSIONS FOUND
SHOULD BE REPORTED IMMEDIATELY TO B&L
HOUSE PLANS PRIOR TO CONSTRUCTION.

4. B&L HOUSE PLANS SHALL NOT BE RESPONSIBLE FOR EXISTING SITE CONDITIONS SUCH AS SOIL BEARING CAPACITY, WATER TABLE, BURIED STRUCTURES, OR PROXIMITY TO PROPERTY LINES.


5. CARBON MONOXIDE DETECTORS TO BE INSTALLED ON EACH LEVEL ADJACENT TO BEDROOMS AND WHERE PROPANE FIREPLACE, GAS AND WOOD BURNING APPLIANCES ARE USED.


ALL DRAWINGS REMAIN THE PROPERTY OF 'B&L HOUSE PLANS'


PROJECT NAME -	REVISI	ON TABLE -	
EVERGREEN PHASE 1 10 UNIT APT BLDG (UNITS 4-8)	REV#	REVISION	DATE
	16	REMOVED ROUGH-INS	FEB 5, 2025
DRAWING NAME -	17	ISSUED FOR CONST.	APR 1, 2025
SITE PLAN	18	REMOVED WET BARS	APR 28, 2025
	19	FDN. REVISIONS	JUL. 21, 2025
SCALE: 1/32" = 1'-0"	20	ADDED BASEMENT UNITS	AUG 12, 2025


SHEET:


**PAGE 2 OF 16** 

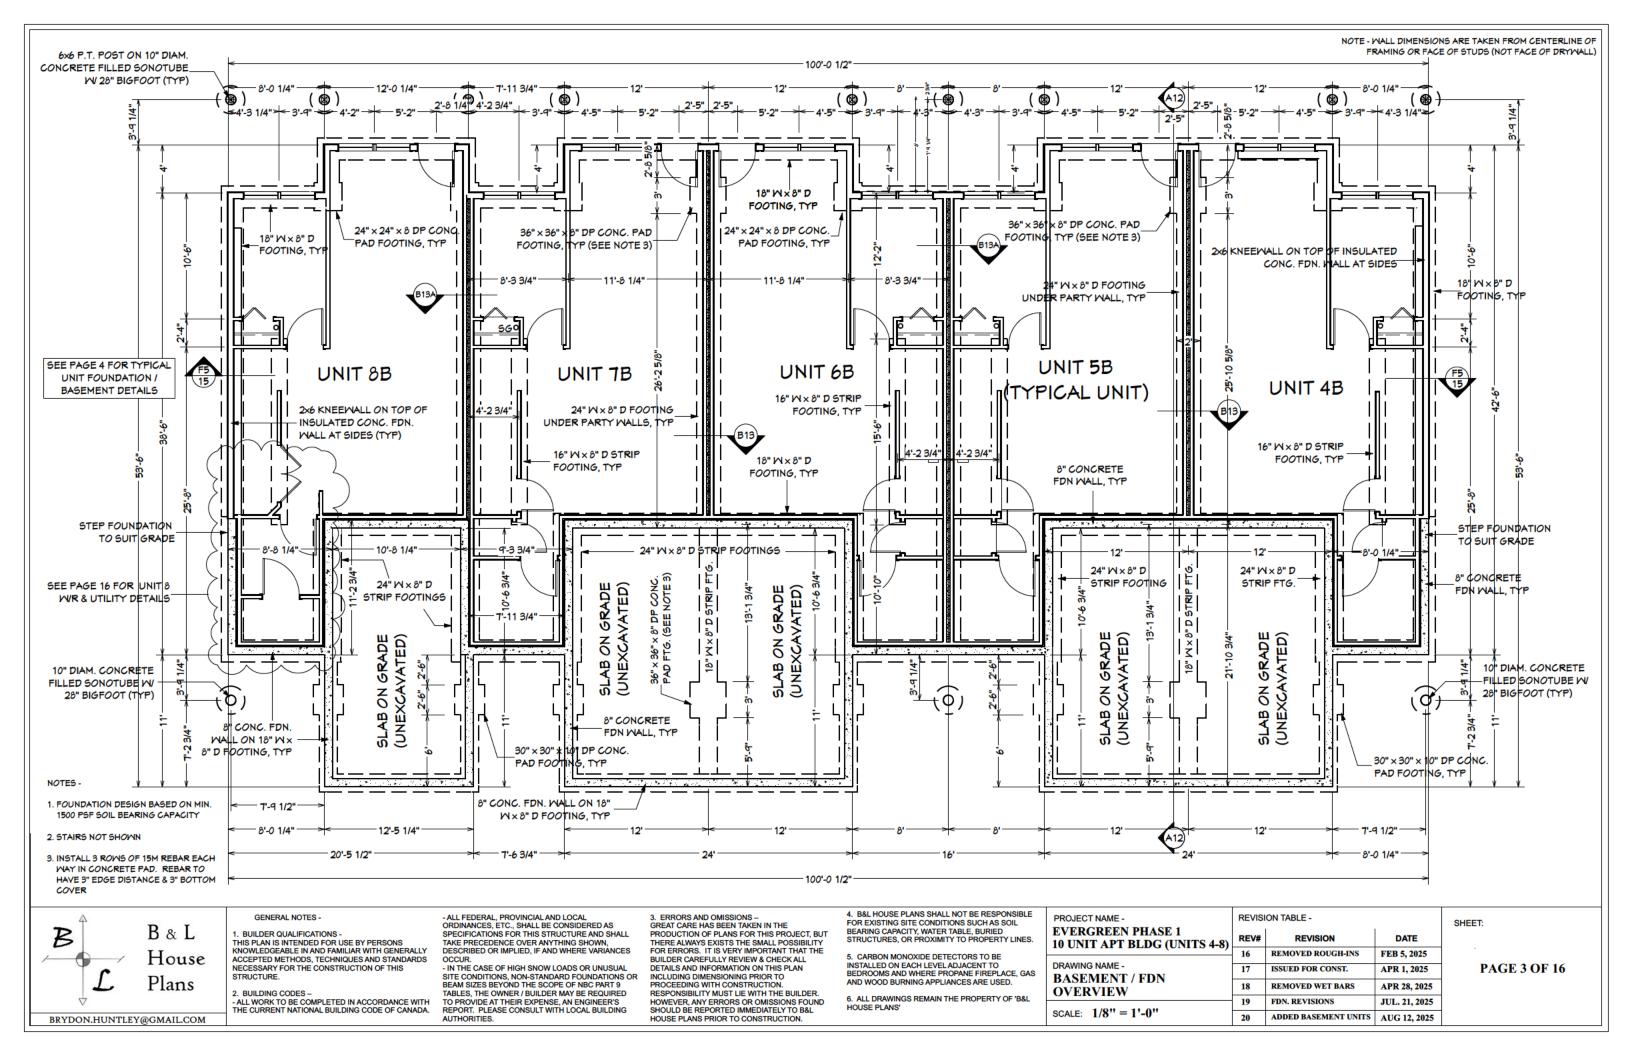

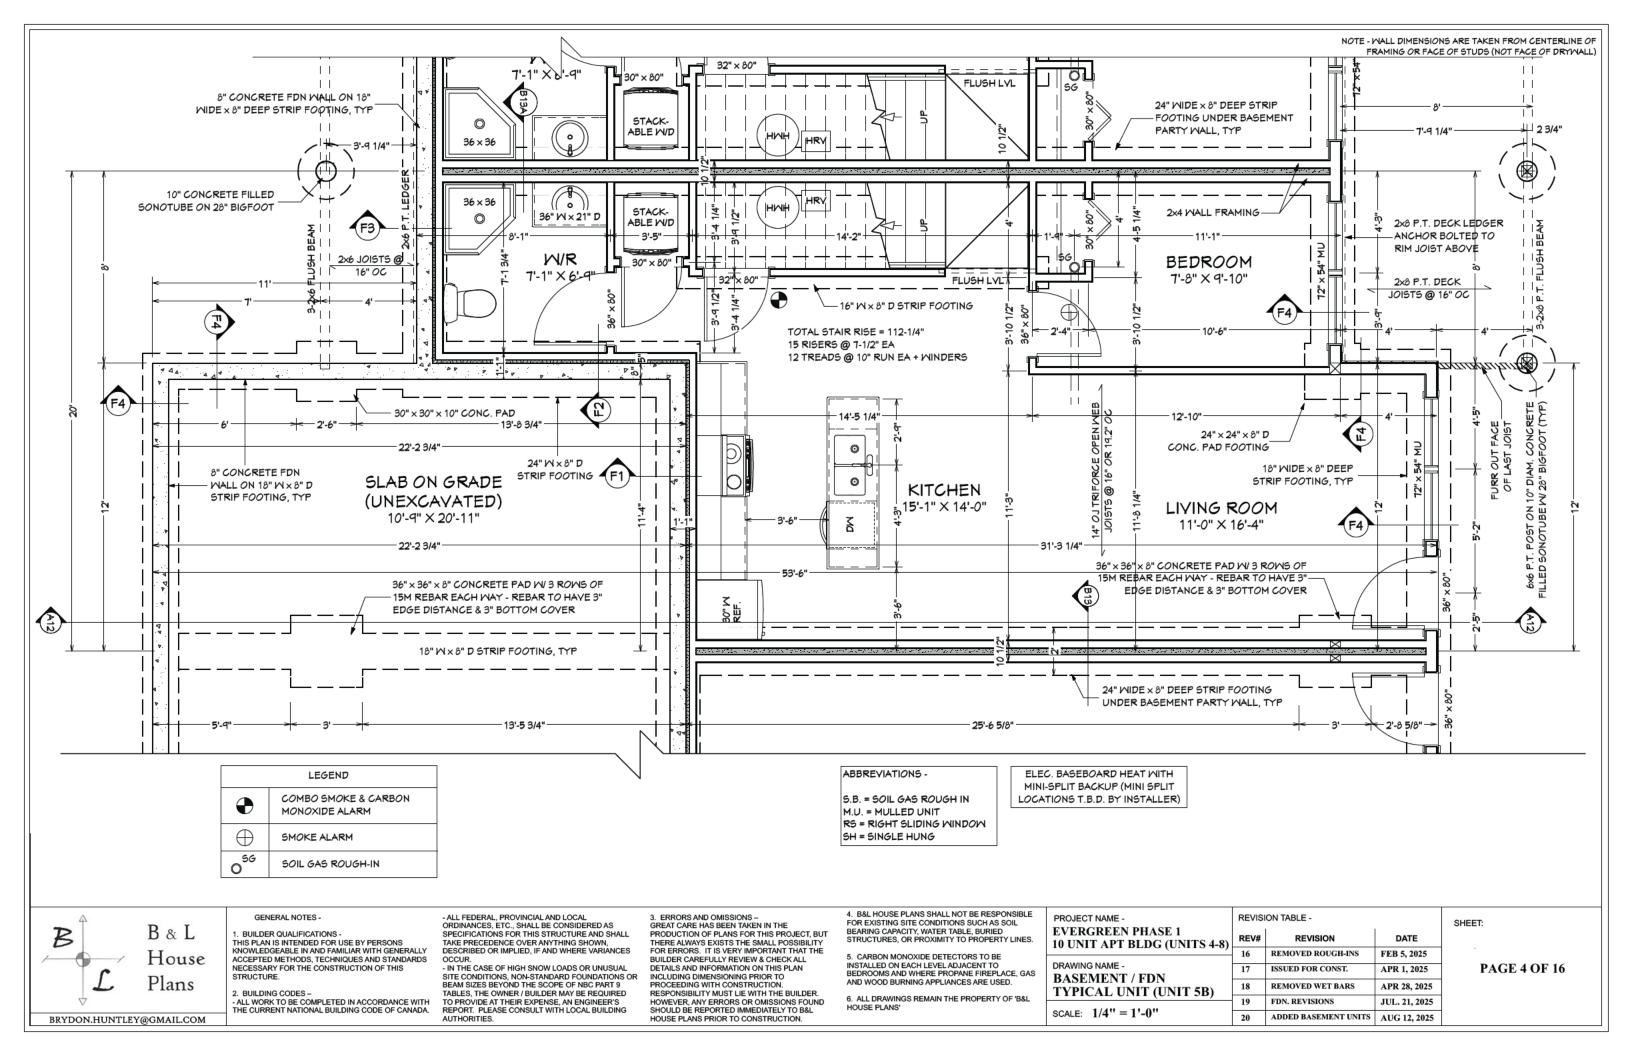

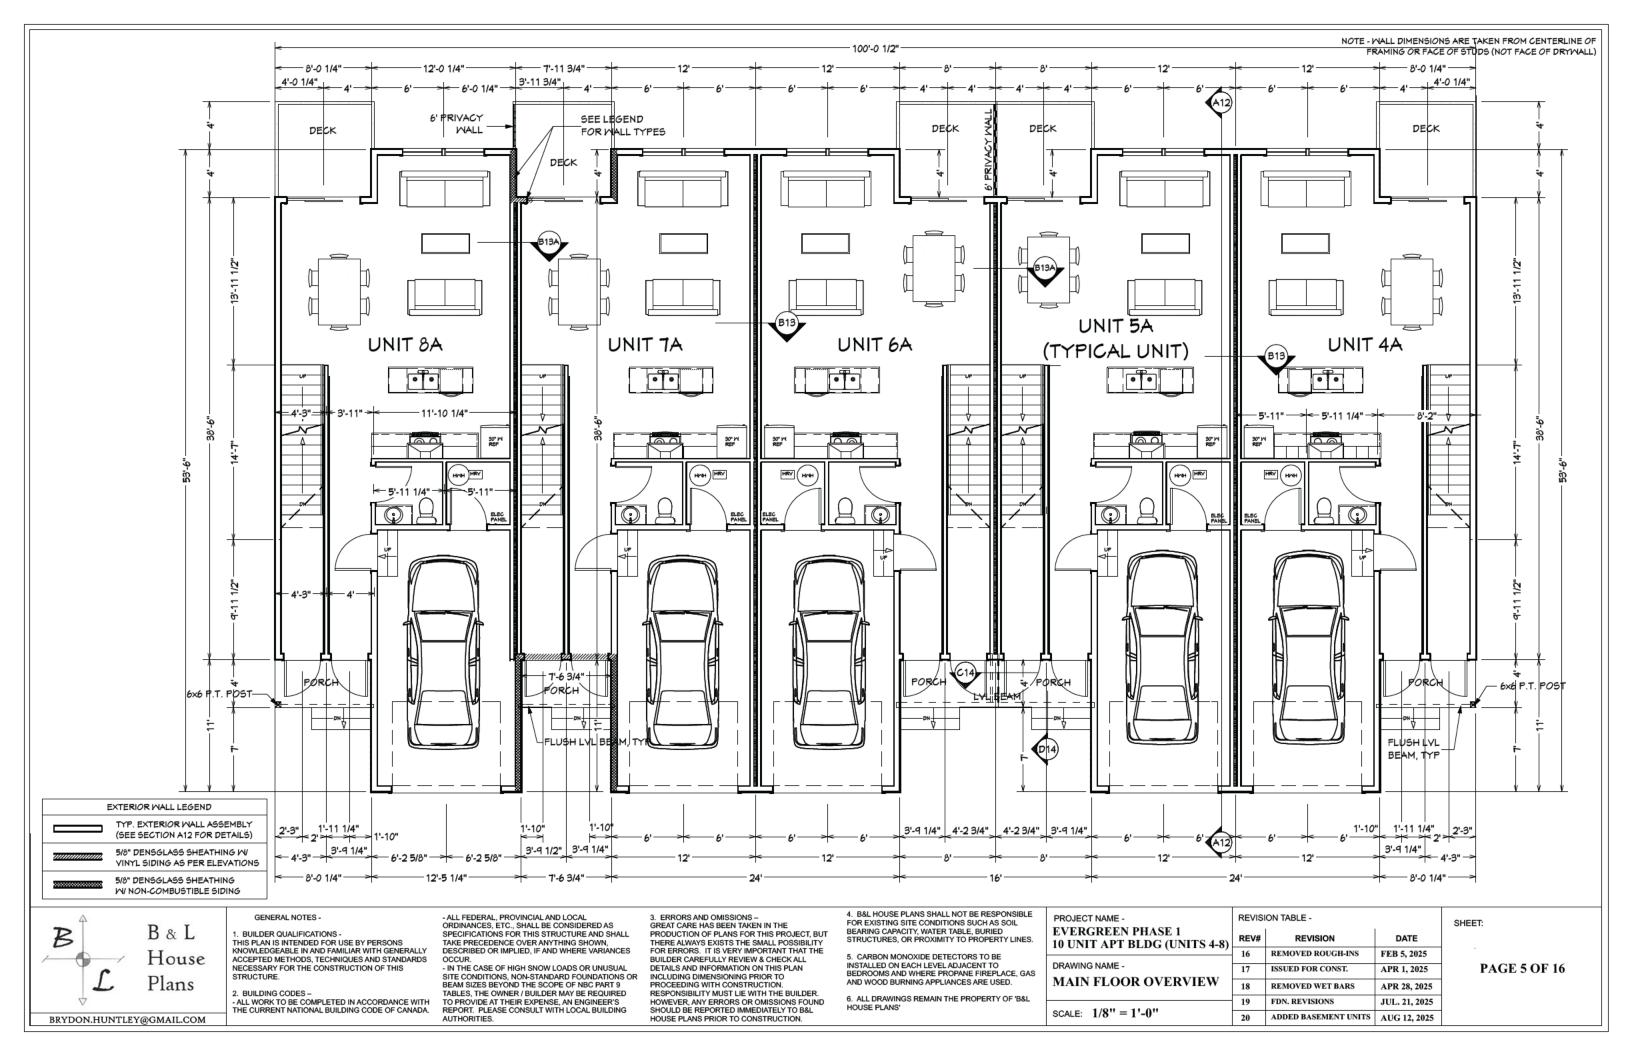

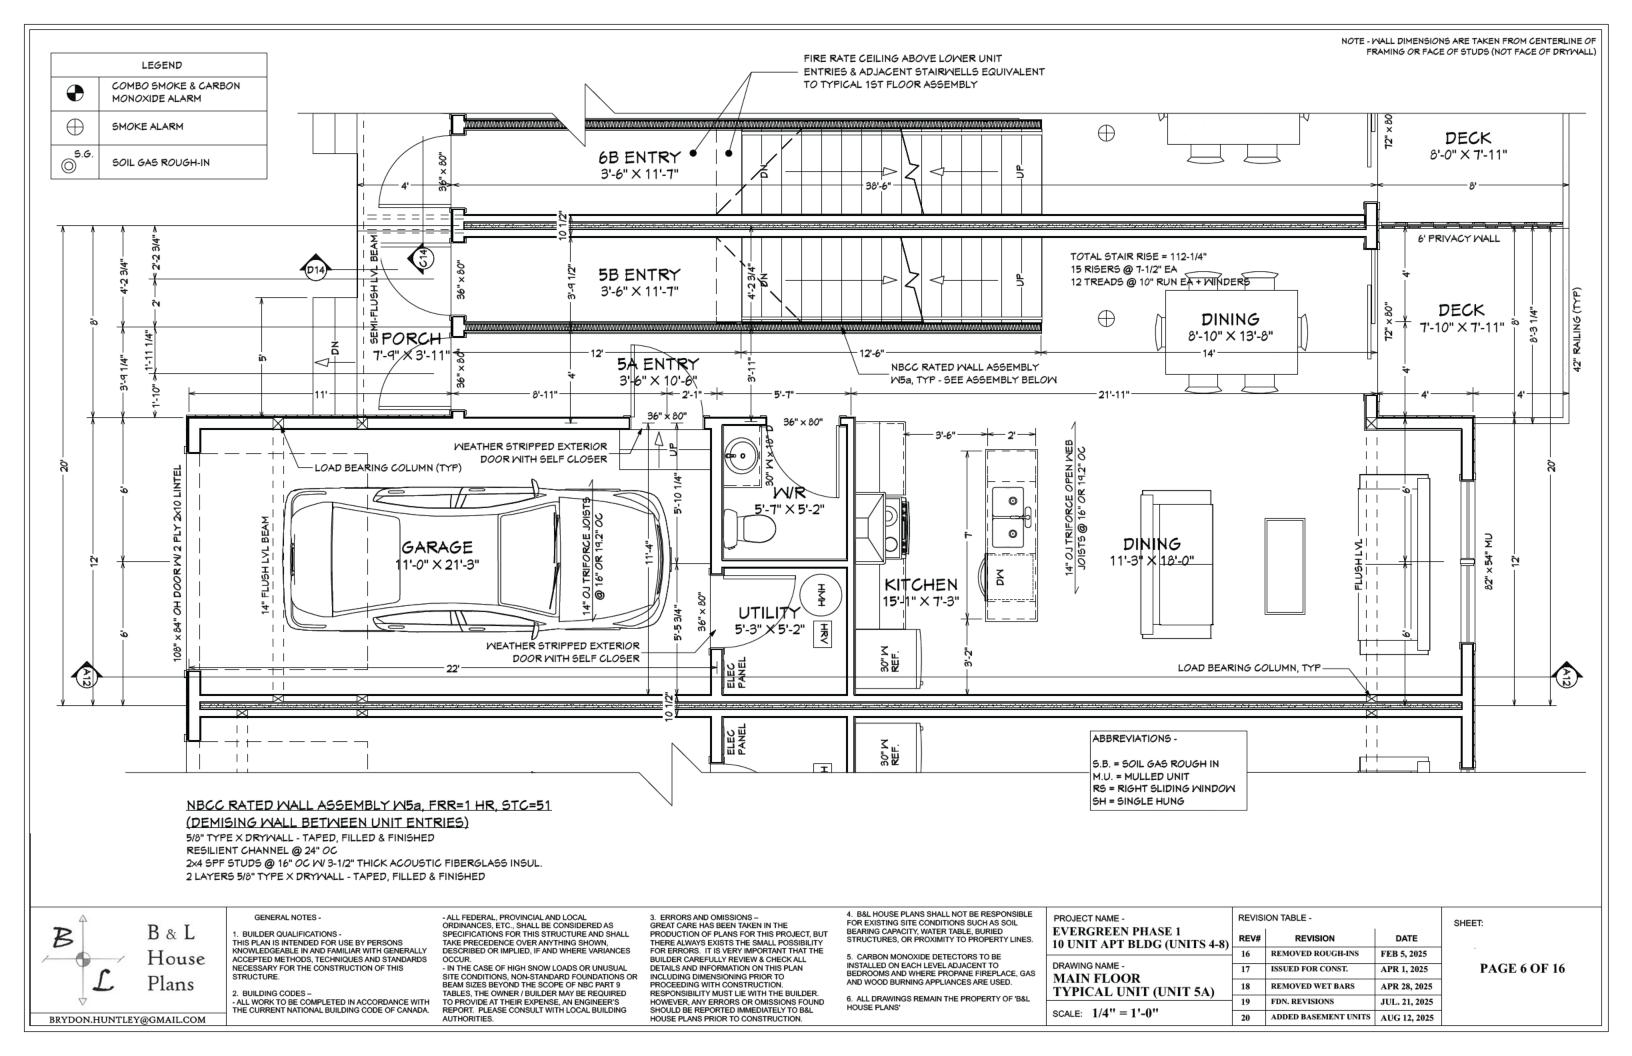

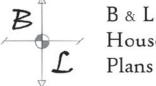

BRYDON.HUNTLEY@GMAIL.COM

NECESSARY FOR THE CONSTRUCTION OF THIS STRUCTURE.

2. BUILDING CODES -

- ALL WORK TO BE COMPLETED IN ACCORDANCE WITH THE CURRENT NATIONAL BUILDING CODE OF CANADA.

OCCUR.


- IN THE CASE OF HIGH SNOW LOADS OR UNUSUAL
SITE CONDITIONS, NON-STANDARD FOUNDATIONS OR
BEAM SIZES BEYOND THE SCOPE OF NBC PART 9
TABLES, THE OWNER / BUILDER MAY BE REQUIRED TO PROVIDE AT THEIR EXPENSE, AN ENGINEER'S REPORT. PLEASE CONSULT WITH LOCAL BUILDING AUTHORITIES.

DETAILS AND INFORMATION ON THIS PLAN INCLUDING DIMENSIONING PRIOR TO PROCEEDING WITH CONSTRUCTION.
RESPONSIBILITY MUST LIE WITH THE BUILDER. HOWEVER, ANY ERRORS OR OMISSIONS FOUND SHOULD BE REPORTED IMMEDIATELY TO B&L HOUSE PLANS PRIOR TO CONSTRUCTION.

5. CARBON MONOXIDE DETECTORS TO BE INSTALLED ON EACH LEVEL ADJACENT TO BEDROOMS AND WHERE PROPANE FIREPLACE, GAS AND WOOD BURNING APPLIANCES ARE USED.

6. ALL DRAWINGS REMAIN THE PROPERTY OF 'B&L HOUSE PLANS'

PROJECT NAME -		REVISION TABLE -				
EVERGREEN PHASE 1 10 UNIT APT BLDG (UNITS 4-8)	REV#	REVISION	DATE			
,	16	REMOVED ROUGH-INS	FEB 5, 2025			
DRAWING NAME -	17	ISSUED FOR CONST.	APR 1, 2025			
2ND FLOOR OVERVIEW	18	REMOVED WET BARS	APR 28, 2025			
4.00	19	FDN. REVISIONS	JUL. 21, 2025			
SCALE: $1/8'' = 1'-0''$	20	ADDED BASEMENT UNITS	AUG 12, 2025			

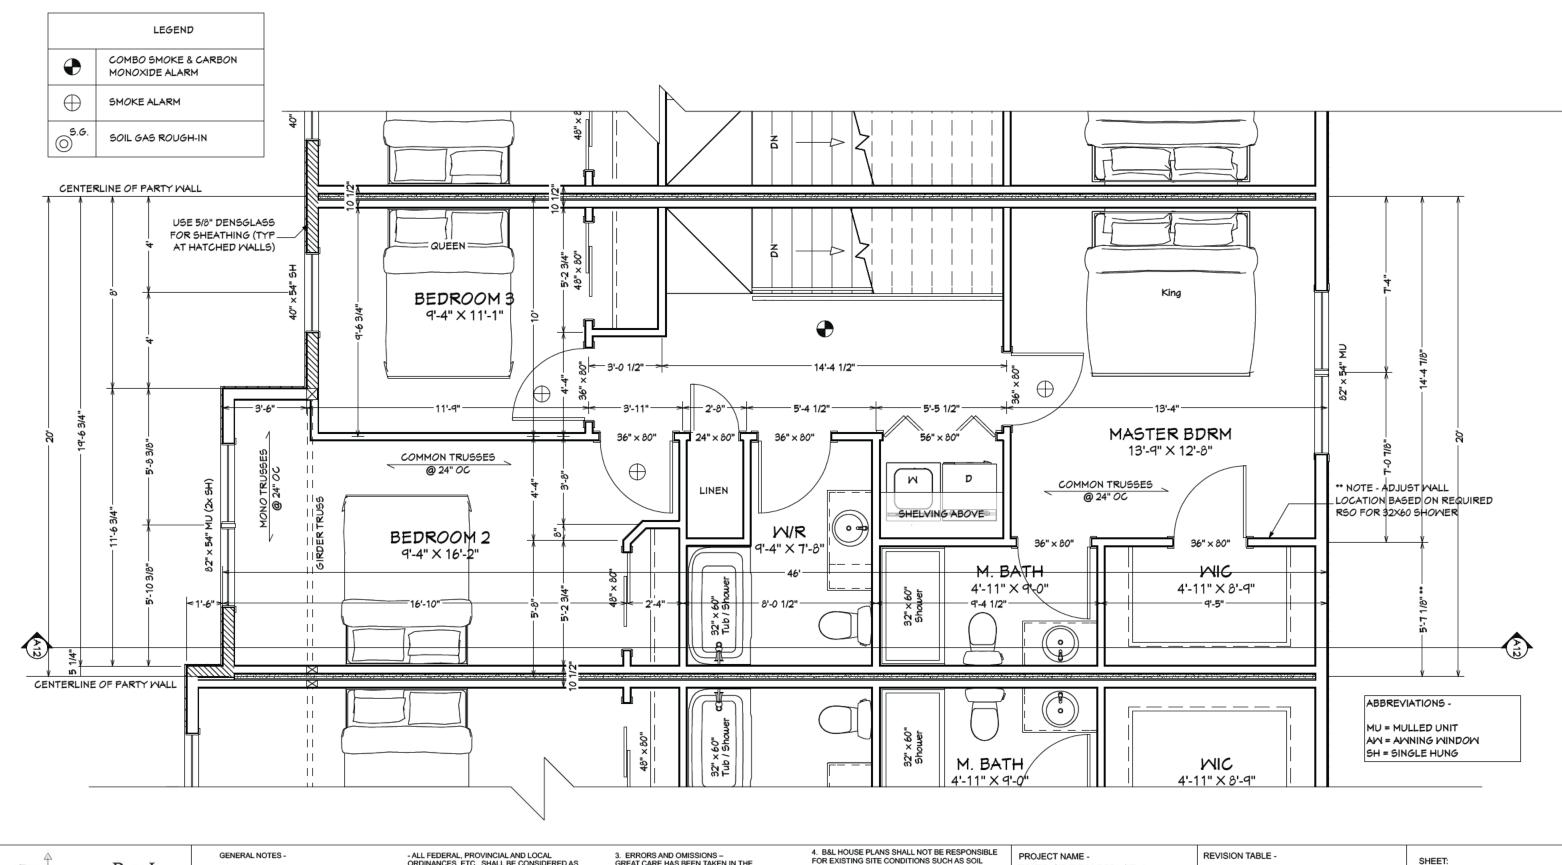

B & L House Plans

BRYDON.HUNTLEY@GMAIL.COM

. BUILDER QUALIFICATIONS -

THIS PLAN IS INTENDED FOR USE BY PERSONS KNOWLEDGEABLE IN AND FAMILIAR WITH GENERALLY ACCEPTED METHODS, TECHNIQUES AND STANDARDS NECESSARY FOR THE CONSTRUCTION OF THIS STRUCTURE.

2. BUILDING CODES -

- ALL WORK TO BE COMPLETED IN ACCORDANCE WITH THE CURRENT NATIONAL BUILDING CODE OF CANADA.

- ALL FEDERAL, PROVINCIAL AND LOCAL ORDINANCES, ETC., SHALL BE CONSIDERED AS SPECIFICATIONS FOR THIS STRUCTURE AND SHALL TAKE PRECEDENCE OVER ANYTHING SHOWN, DESCRIBED OR IMPLIED, IF AND WHERE VARIANCES

OCCUR OCCUR.

- IN THE CASE OF HIGH SNOW LOADS OR UNUSUAL
SITE CONDITIONS, NON-STANDARD FOUNDATIONS OR
BEAM SIZES BEYOND THE SCOPE OF NBC PART 9
TABLES, THE OWNER / BUILDER MAY BE REQUIRED TO PROVIDE AT THEIR EXPENSE, AN ENGINEER'S REPORT. PLEASE CONSULT WITH LOCAL BUILDING AUTHORITIES.

GREAT CARE HAS BEEN TAKEN IN THE PRODUCTION OF PLANS FOR THIS PROJECT, BUT THERE ALWAYS EXISTS THE SMALL POSSIBILITY FOR ERRORS. IT IS VERY IMPORTANT THAT THE BUILDER CAREFULLY REVIEW & CHECK ALL DETAILS AND INFORMATION ON THIS PLAN INCLUDING DIMENSIONING PRIOR TO PROCEEDING WITH CONSTRUCTION. RESPONSIBILITY MUST LIE WITH THE BUILDER. HOWEVER, ANY ERRORS OR OMISSIONS FOUND SHOULD BE REPORTED IMMEDIATELY TO B&L HOUSE PLANS PRIOR TO CONSTRUCTION. 4. BELLINOUS PLANS STALLINOT BE RESPONSIBLE FOR EXISTING SITE CONDITIONS SUCH AS SOIL BEARING CAPACITY, WATER TABLE, BURIED STRUCTURES, OR PROXIMITY TO PROPERTY LINES.

5. CARBON MONOXIDE DETECTORS TO BE INSTALLED ON EACH LEVEL ADJACENT TO BEDROOMS AND WHERE PROPANE FIREPLACE, GAS AND WOOD BURNING APPLIANCES ARE USED.

6. ALL DRAWINGS REMAIN THE PROPERTY OF 'B&L HOUSE PLANS

PROJECT NAME -		REVISION TABLE -			
EVERGREEN PHASE 1 10 UNIT APT BLDG (UNITS 4-8)	REV#	REVISION	DATE		
DRAWING NAME - 2ND FLOOR TYPICAL UNIT (UNIT 5A)	16	REMOVED ROUGH-INS	FEB 5, 2025		
	17	ISSUED FOR CONST.	APR 1, 2025		
	18	REMOVED WET BARS	APR 28, 2025		
SCALE: 1/4" = 1'-0"	19	FDN. REVISIONS	JUL. 21, 2025		
	20	ADDED BASEMENT UNITS	AUG 12, 2025		

**PAGE 8 OF 16** 





1. BUILDER QUALIFICATIONS -

THIS PLAN IS INTENDED FOR USE BY PERSONS KNOWLEDGEABLE IN AND FAMILIAR WITH GENERALLY ACCEPTED METHODS, TECHNIQUES AND STANDARDS NECESSARY FOR THE CONSTRUCTION OF THIS STRUCTURE.

2. BUILDING CODES -

- ALL WORK TO BE COMPLETED IN ACCORDANCE WITH THE CURRENT NATIONAL BUILDING CODE OF CANADA.

- ALL FEDERAL, PROVINCIAL AND LOCAL ORDINANCES, ETC., SHALL BE CONSIDERED AS SPECIFICATIONS FOR THIS STRUCTURE AND SHALL TAKE PRECEDENCE OVER ANYTHING SHOWN, DESCRIBED OR IMPLIED, IF AND WHERE VARIANCES OCCUR.

OCCUR.

- IN THE CASE OF HIGH SNOW LOADS OR UNUSUAL
SITE CONDITIONS, NON-STANDARD FOUNDATIONS OR
BEAM SIZES BEYOND THE SCOPE OF NBC PART 9
TABLES, THE OWNER / BUILDER MAY BE REQUIRED TO PROVIDE AT THEIR EXPENSE, AN ENGINEER'S REPORT. PLEASE CONSULT WITH LOCAL BUILDING AUTHORITIES.

3. ERRORS AND OMISSIONS – GREAT CARE HAS BEEN TAKEN IN THE PRODUCTION OF PLANS FOR THIS PROJECT, BUT THERE ALWAYS EXISTS THE SMALL POSSIBILITY FOR ERRORS. IT IS VERY IMPORTANT THAT THE BUILDER CAREFULLY REVIEW & CHECK ALL DETAILS AND INFORMATION ON THIS PLAN
INCLUDING DIMENSIONING PRIOR TO PROCEEDING WITH CONSTRUCTION. RESPONSIBILITY MUST LIE WITH THE BUILDER. HOWEVER, ANY ERRORS OR OMISSIONS FOUND SHOULD BE REPORTED IMMEDIATELY TO B&L HOUSE PLANS PRIOR TO CONSTRUCTION.

4. B&L HOUSE PLANS SHALL NOT BE RESPONSIBLE FOR EXISTING SITE CONDITIONS SUCH AS SOIL BEARING CAPACITY, WATER TABLE, BURIED STRUCTURES, OR PROXIMITY TO PROPERTY LINES.

5. CARBON MONOXIDE DETECTORS TO BE INSTALLED ON EACH LEVEL ADJACENT TO BEDROOMS AND WHERE PROPANE FIREPLACE, GAS AND WOOD BURNING APPLIANCES ARE USED.

ALL DRAWINGS REMAIN THE PROPERTY OF 'B&L HOUSE PLANS'

PROJECT NAME - EVERGREEN PHASE 1 10 UNIT APT BLDG (UNITS 4-8)	
DRAWING NAME -	ŀ

FRONT ELEVATION

SCALE: 1/8" = 1'-0"


	OIT IT IDEE	
REV#	REVISION	DATE
16	REMOVED ROUGH-INS	FEB 5, 2025
17	ISSUED FOR CONST.	APR 1, 2025
18	REMOVED WET BARS	APR 28, 2025
19	FDN. REVISIONS	JUL. 21, 2025
20	ADDED BASEMENT UNITS	AUG 12, 2025

**REVISION TABLE -**

SHEET:

**PAGE 9 OF 16** 


**PAGE 10 OF 16** 

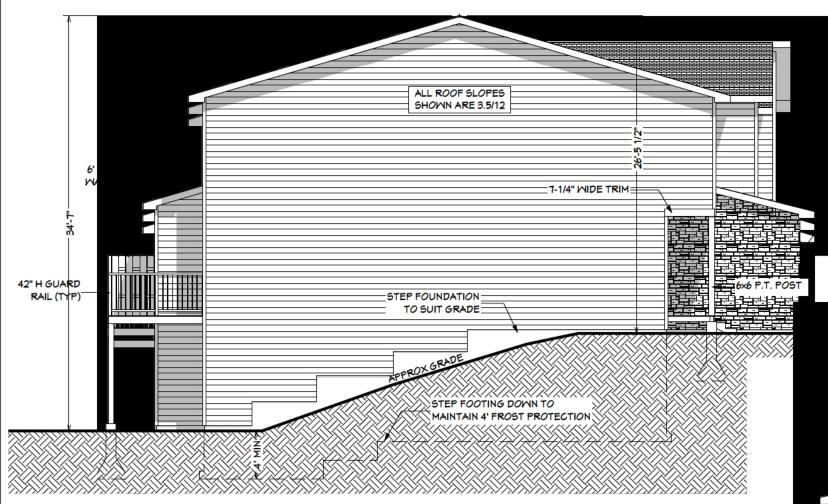

RIGHT ELEVATION

# STEP FOUNDATION WALL TO SUIT GRADE LIMIT EXPOSED FOUNDATION WALL TO 3:3' VERTICAL HEIGHT APPROX GRADE STEP FOOTING TO MAINTAIN 4 FROST PROTECTION

# LEFT ELEVATION

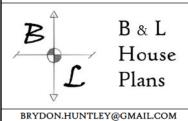

GENERAL NOTES -

BUILDER QUALIFICATIONS THIS PLAN IS INTENDED FOR USE BY PERSONS
KNOWLEDGEABLE IN AND FAMILIAR WITH GENERALLY
ACCEPTED METHODS, TECHNIQUES AND STANDARDS
NECESSARY FOR THE CONSTRUCTION OF THIS
STRUCTURE.

2. BUILDING CODES –
- ALL WORK TO BE COMPLETED IN ACCORDANCE WITH
THE CURRENT NATIONAL BUILDING CODE OF CANADA.

- ALL FEDERAL, PROVINCIAL AND LOCAL ORDINANCES, ETC., SHALL BE CONSIDERED AS SPECIFICATIONS FOR THIS STRUCTURE AND SHALL TAKE PRECEDENCE OVER ANYTHING SHOWN, DESCRIBED OR IMPLIED, IF AND WHERE VARIANCES OCCULR.

OCCUR.

IN THE CASE OF HIGH SNOW LOADS OR UNUSUAL SITE CONDITIONS, NON-STANDARD FOUNDATIONS OR BEAM SIZES BEYOND THE SCOPE OF NBC PART 9 TABLES, THE OWNER / BUILDER MAY BE REQUIRED TO PROVIDE AT THEIR EXPENSE, AN ENGINEER'S REPORT. PLEASE CONSULT WITH LOCAL BUILDING AUTHORITIES.

3. ERRORS AND OMISSIONS —
GREAT CARE HAS BEEN TAKEN IN THE
PRODUCTION OF PLANS FOR THIS PROJECT, BUT
THERE ALWAYS EXISTS THE SMALL POSSIBILITY
FOR ERRORS. IT IS VERY IMPORTANT THAT THE
BUILDER CAREFULLY REVIEW & CHECK ALL
DETAILS AND INFORMATION ON THIS PLAN
INCLUDING DIMENSIONING PRIOR TO
PROCEEDING WITH CONSTRUCTION.
RESPONSIBILITY MUST LIE WITH THE BUILDER.
HOWEVER, ANY ERRORS OR OMISSIONS FOUND
SHOULD BE REPORTED IMMEDIATELY TO BÂL
HOUSE PLANS PRIOR TO CONSTRUCTION.


4. B&L HOUSE PLANS SHALL NOT BE RESPONSIBLE FOR EXISTING SITE CONDITIONS SUCH AS SOIL BEARING CAPACITY, WATER TABLE, BURIED STRUCTURES, OR PROXIMITY TO PROPERTY LINES.


VINYL 'STONE' VENEER SIDING

5. CARBON MONOXIDE DETECTORS TO BE INSTALLED ON EACH LEVEL ADJACENT TO BEDROOMS AND WHERE PROPANE FIREPLACE, GAS AND WOOD BURNING APPLIANCES ARE USED.

ALL DRAWINGS REMAIN THE PROPERTY OF 'B&L HOUSE PLANS'

PROJECT NAME - EVERGREEN PHASE 1 10 UNIT APT BLDG (UNITS 4-8)		REVISION TABLE -				
		REVISION	DATE			
TO CHAIT AN I BEDG (CHAIRS 4-0)	16	REMOVED ROUGH-INS	FEB 5, 2025			
DRAWING NAME -	17	ISSUED FOR CONST.	APR 1, 2025			
L & R ELEVATIONS	18	REMOVED WET BARS	APR 28, 2025			
	19	FDN. REVISIONS	JUL. 21, 2025			
SCALE: 1/8" = 1'-0"		ADDED BASEMENT UNITS	AUG 12, 2025			

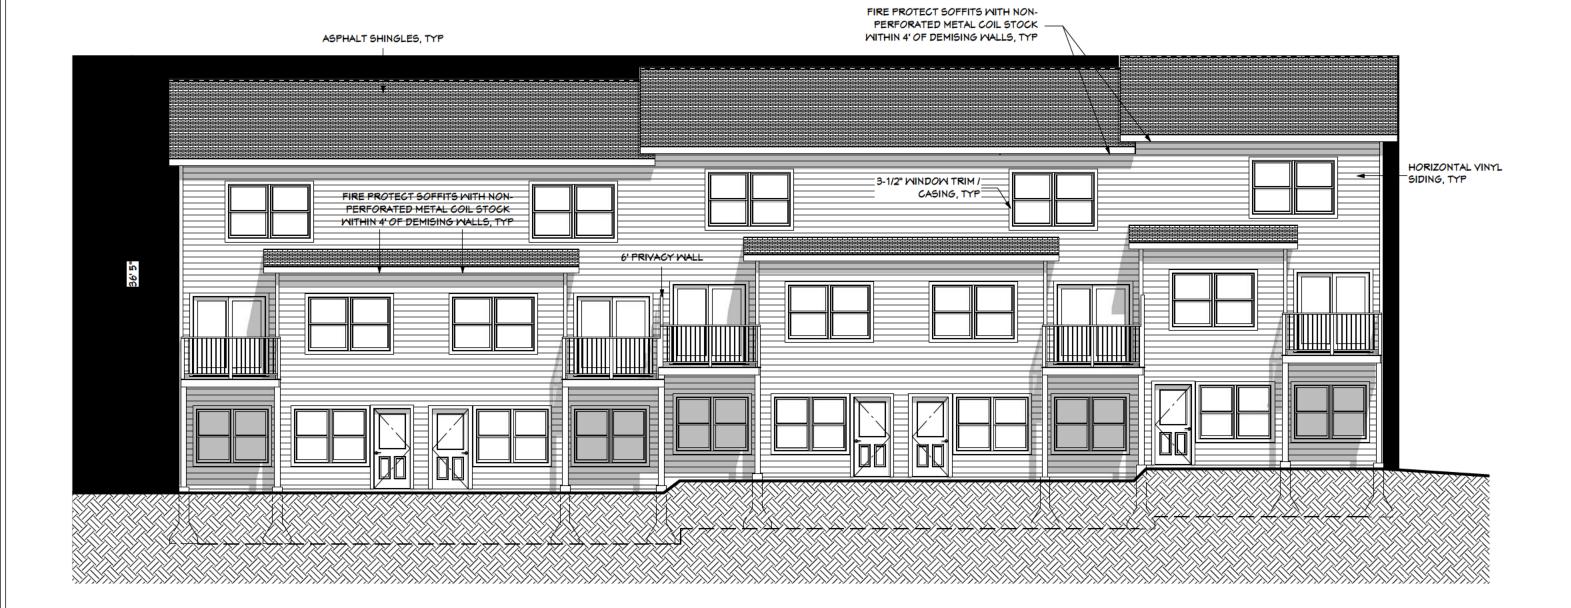

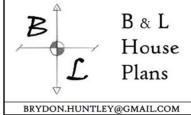

1. BUILDER QUALIFICATIONS -

THIS PLAN IS INTENDED FOR USE BY PERSONS
KNOWLEDGEABLE IN AND FAMILIAR WITH GENERALLY
ACCEPTED METHODS, TECHNIQUES AND STANDARDS NECESSARY FOR THE CONSTRUCTION OF THIS STRUCTURE.

2. BUILDING CODES -

- ALL WORK TO BE COMPLETED IN ACCORDANCE WITH THE CURRENT NATIONAL BUILDING CODE OF CANADA.

- ALL FEDERAL, PROVINCIAL AND LOCAL ORDINANCES, ETC., SHALL BE CONSIDERED AS SPECIFICATIONS FOR THIS STRUCTURE AND SHALL TAKE PRECEDENCE OVER ANYTHING SHOWN, DESCRIBED OR IMPLIED, IF AND WHERE VARIANCES OCCUR.

OCCUR.

- IN THE CASE OF HIGH SNOW LOADS OR UNUSUAL
SITE CONDITIONS, NON-STANDARD FOUNDATIONS OR
BEAM SIZES BEYOND THE SCOPE OF NBC PART 9
TABLES, THE OWNER / BUILDER MAY BE REQUIRED TO PROVIDE AT THEIR EXPENSE, AN ENGINEER'S REPORT. PLEASE CONSULT WITH LOCAL BUILDING AUTHORITIES.


3. ERRORS AND OMISSIONS – GREAT CARE HAS BEEN TAKEN IN THE PRODUCTION OF PLANS FOR THIS PROJECT, BUT THERE ALWAYS EXISTS THE SMALL POSSIBILITY FOR ERRORS. IT IS VERY IMPORTANT THAT THE BUILDER CAREFULLY REVIEW & CHECK ALL DETAILS AND INFORMATION ON THIS PLAN INCLUDING DIMENSIONING PRIOR TO PROCEEDING WITH CONSTRUCTION.
RESPONSIBILITY MUST LIE WITH THE BUILDER. HOWEVER, ANY ERRORS OR OMISSIONS FOUND SHOULD BE REPORTED IMMEDIATELY TO B&L HOUSE PLANS PRIOR TO CONSTRUCTION.

4. B&L HOUSE PLANS SHALL NOT BE RESPONSIBLE FOR EXISTING SITE CONDITIONS SUCH AS SOIL BEARING CAPACITY, WATER TABLE, BURIED STRUCTURES, OR PROXIMITY TO PROPERTY LINES.

5. CARBON MONOXIDE DETECTORS TO BE INSTALLED ON EACH LEVEL ADJACENT TO BEDROOMS AND WHERE PROPANE FIREPLACE, GAS AND WOOD BURNING APPLIANCES ARE USED.

6. ALL DRAWINGS REMAIN THE PROPERTY OF 'B&L HOUSE PLANS'

PROJECT NAME -	REVISI	ON TABLE -		SHEET:
EVERGREEN PHASE 1 10 UNIT APT BLDG (UNITS 4-8)	REV#	REVISION	DATE	
10 01111111 1 222 3 (011113 1 3)	16	REMOVED ROUGH-INS	FEB 5, 2025	•
DRAWING NAME -				DACE 11 OF 16
DIOWING NAME -	17	ISSUED FOR CONST.	APR 1, 2025	<b>PAGE 11 OF 16</b>
REAR ELEVATION	18	REMOVED WET BARS	APR 28, 2025	
	19	FDN. REVISIONS	JUL. 21, 2025	
SCALE: $1/8'' = 1'-0''$				
30ALL: 1/8 -1-0	20	ADDED BASEMENT UNITS	AUG 12, 2025	

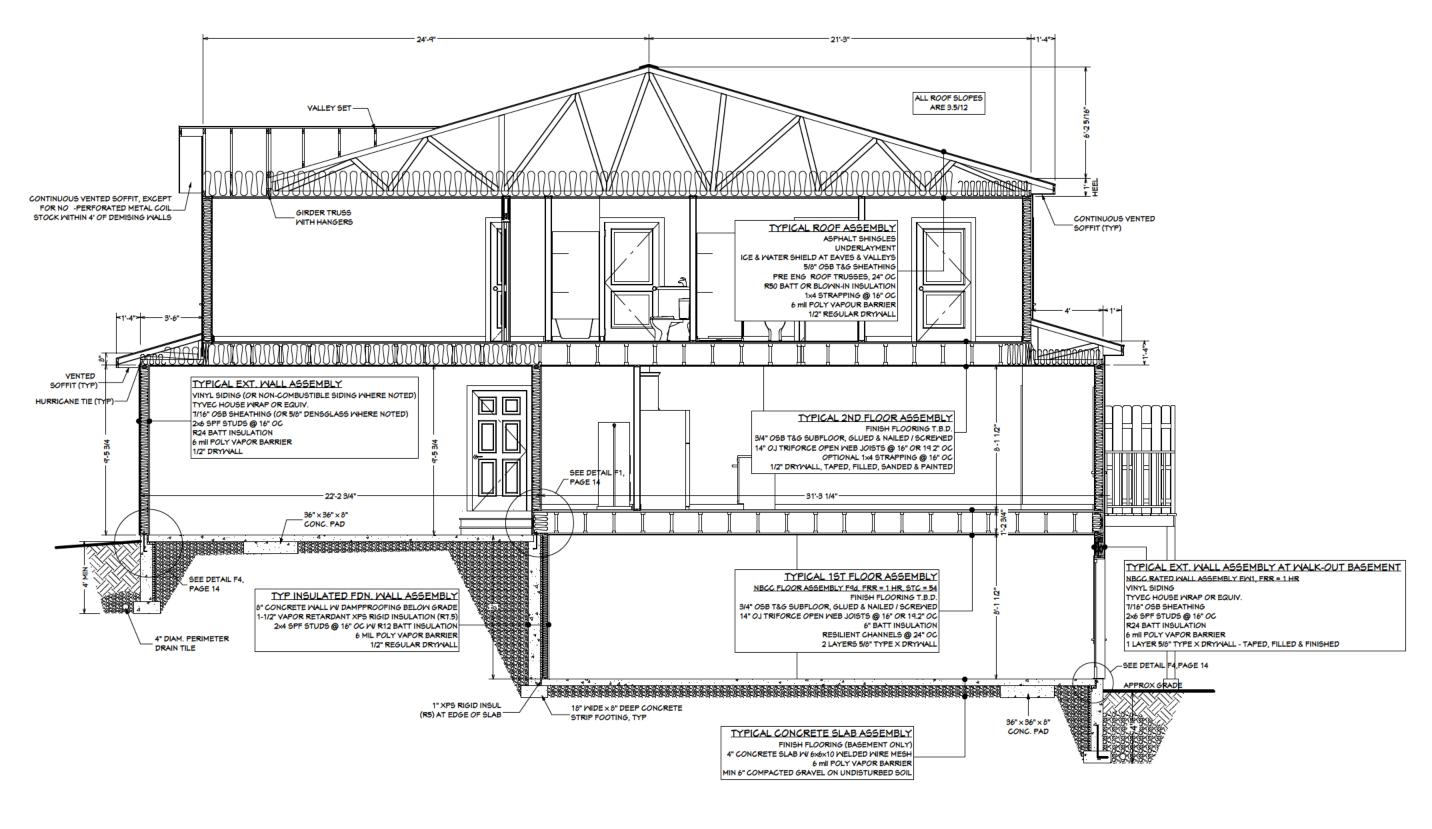



. BUILDER QUALIFICATIONS -

THIS PLAN IS INTENDED FOR USE BY PERSONS KNOWLEDGEABLE IN AND FAMILIAR WITH GENERALLY ACCEPTED METHODS, TECHNIQUES AND STANDARDS NECESSARY FOR THE CONSTRUCTION OF THIS STRUCTURE.

2. BUILDING CODES -

- ALL WORK TO BE COMPLETED IN ACCORDANCE WITH THE CURRENT NATIONAL BUILDING CODE OF CANADA.

- ALL FEDERAL, PROVINCIAL AND LOCAL ORDINANCES, ETC., SHALL BE CONSIDERED AS SPECIFICATIONS FOR THIS STRUCTURE AND SHALL TAKE PRECEDENCE OVER ANYTHING SHOWN, DESCRIBED OR IMPLIED, IF AND WHERE VARIANCES OCCUR.

OCCUR.

- IN THE CASE OF HIGH SNOW LOADS OR UNUSUAL
SITE CONDITIONS, NON-STANDARD FOUNDATIONS OR
BEAM SIZES BEYOND THE SCOPE OF NBC PART 9
TABLES, THE OWNER / BUILDER MAY BE REQUIRED TO PROVIDE AT THEIR EXPENSE, AN ENGINEER'S REPORT. PLEASE CONSULT WITH LOCAL BUILDING AUTHORITIES.

3. ERRORS AND OMISSIONS -GREAT CARE HAS BEEN TAKEN IN THE PRODUCTION OF PLANS FOR THIS PROJECT, BUT THERE ALWAYS EXISTS THE SMALL POSSIBILITY FOR ERRORS. IT IS VERY IMPORTANT THAT THE BUILDER CAREFULLY REVIEW & CHECK ALL DETAILS AND INFORMATION ON THIS PLAN INCLUDING DIMENSIONING PRIOR TO PROCEEDING WITH CONSTRUCTION. RESPONSIBILITY MUST LIE WITH THE BUILDER. HOWEVER, ANY ERRORS OR OMISSIONS FOUND SHOULD BE REPORTED IMMEDIATELY TO B&L HOUSE PLANS PRIOR TO CONSTRUCTION. 4. B&L HOUSE PLANS SHALL NOT BE RESPONSIBLE FOR EXISTING SITE CONDITIONS SUCH AS SOIL BEARING CAPACITY, WATER TABLE, BURIED STRUCTURES, OR PROXIMITY TO PROPERTY LINES.


5. CARBON MONOXIDE DETECTORS TO BE INSTALLED ON EACH LEVEL ADJACENT TO BEDROOMS AND WHERE PROPANE FIREPLACE, GAS AND WOOD BURNING APPLIANCES ARE USED.


6. ALL DRAWINGS REMAIN THE PROPERTY OF 'B&L HOUSE PLANS

PROJECT NAME -		REVISION TABLE -				
EVERGREEN PHASE 1 10 UNIT APT BLDG (UNITS 4-8)	REV#	REVISION	DATE			
10 01111111 1 222 0 (011115 1 0)	16	REMOVED ROUGH-INS	FEB 5, 2025	ĺ		
DRAWING NAME -	17	ISSUED FOR CONST.	APR 1, 2025			
SECTION A12	18	REMOVED WET BARS	APR 28, 2025			
	19	FDN. REVISIONS	JUL. 21, 2025			
SCALE: 3/16" = 1'-0"		ADDED BASEMENT UNITS	AUG 12, 2025			


SHEET:

**PAGE 12 OF 16** 

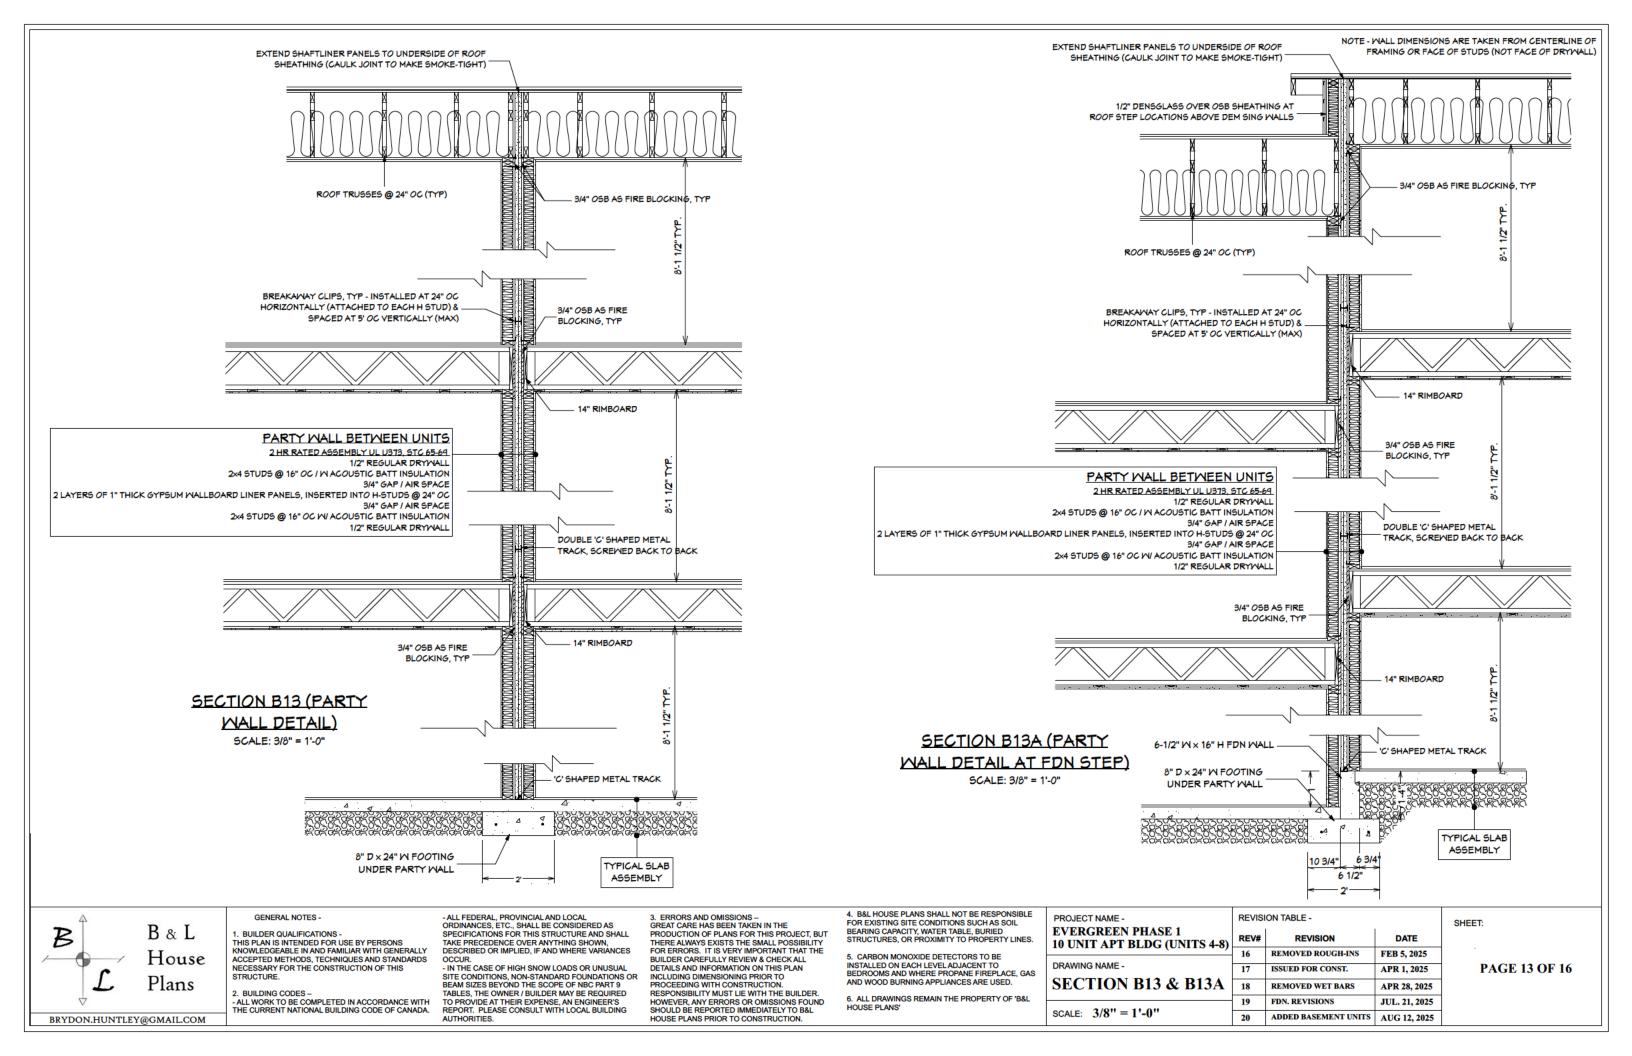

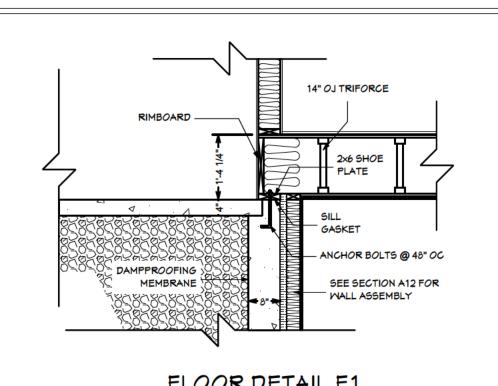

14" OJ TRIFORCE RIMBOARD -ごのごのごのごのご GASKET 2×6 SHOE PLATE ANCHOR BOLTS @ 48" OC DAMPPROOFING MEMBRANE SEE SECTION A12 FOR WALL ASSEMBLY

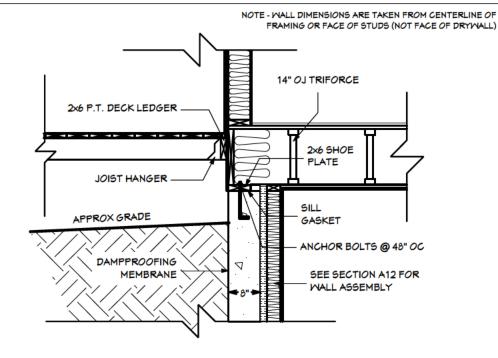



# FLOOR DETAIL F2


SCALE: 1/2" = 1'-0"

# FLOOR DETAIL F3

SCALE: 1/2" = 1'-0"

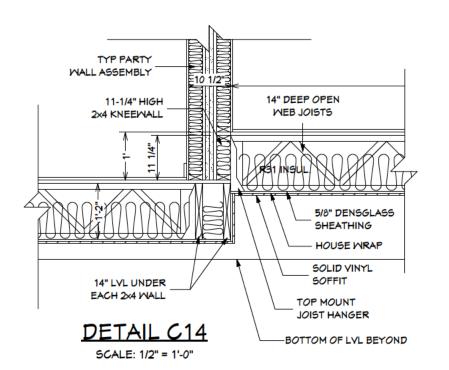

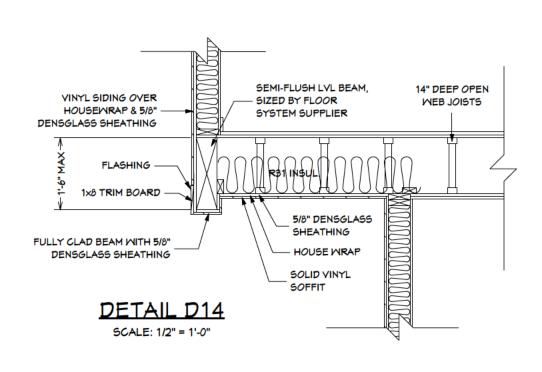

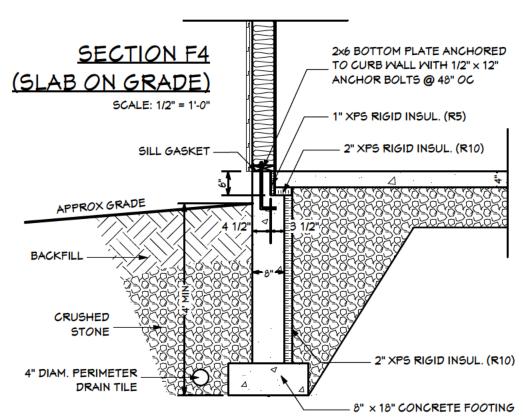



### GENERAL NOTES -

. BUILDER QUALIFICATIONS -

THIS PLAN IS INTENDED FOR USE BY PERSONS
KNOWLEDGEABLE IN AND FAMILIAR WITH GENERALLY
ACCEPTED METHODS, TECHNIQUES AND STANDARDS NECESSARY FOR THE CONSTRUCTION OF THIS STRUCTURE.

2. BUILDING CODES -

- ALL WORK TO BE COMPLETED IN ACCORDANCE WITH THE CURRENT NATIONAL BUILDING CODE OF CANADA.

- ALL FEDERAL, PROVINCIAL AND LOCAL ORDINANCES, ETC., SHALL BE CONSIDERED AS SPECIFICATIONS FOR THIS STRUCTURE AND SHALL TAKE PRECEDENCE OVER ANYTHING SHOWN, DESCRIBED OR IMPLIED, IF AND WHERE VARIANCES OCCUR.

- IN THE CASE OF HIGH SNOW LOADS OR UNUSUAL SITE CONDITIONS, NON-STANDARD FOUNDATIONS OR BEAM SIZES BEYOND THE SCOPE OF NBC PART 9 TABLES, THE OWNER / BUILDER MAY BE REQUIRED TO PROVIDE AT THEIR EXPENSE, AN ENGINEER'S REPORT. PLEASE CONSULT WITH LOCAL BUILDING AUTHORITIES.

3. ERRORS AND OMISSIONS -GREAT CARE HAS BEEN TAKEN IN THE PRODUCTION OF PLANS FOR THIS PROJECT, BUT THERE ALWAYS EXISTS THE SMALL POSSIBILITY FOR ERRORS. IT IS VERY IMPORTANT THAT THE BUILDER CAREFULLY REVIEW & CHECK ALL DETAILS AND INFORMATION ON THIS PLAN INCLUDING DIMENSIONING PRIOR TO PROCEEDING WITH CONSTRUCTION. RESPONSIBILITY MUST LIE WITH THE BUILDER. HOWEVER, ANY ERRORS OR OMISSIONS FOUND SHOULD BE REPORTED IMMEDIATELY TO B&L HOUSE PLANS PRIOR TO CONSTRUCTION.

4. B&L HOUSE PLANS SHALL NOT BE RESPONSIBLE 4. BEL HOUSE PLANS SHELLHOT BE RESPONSIBLE FOR EXISTING SITE CONDITIONS SUCH AS SOIL BEARING CAPACITY, WATER TABLE, BURIED STRUCTURES, OR PROXIMITY TO PROPERTY LINES.

5. CARBON MONOXIDE DETECTORS TO BE INSTALLED ON EACH LEVEL ADJACENT TO BEDROOMS AND WHERE PROPANE FIREPLACE, GAS AND WOOD BURNING APPLIANCES ARE USED.

6. ALL DRAWINGS REMAIN THE PROPERTY OF 'B&L HOUSE PLANS


ROJECT NAME - REVISION TABLE -		REVISION TABLE - SHEET:		SHEET:
EVERGREEN PHASE 1 10 UNIT APT BLDG (UNITS 4-8)	REV#	REVISION	DATE	
10 011111111111111111111111111111111111	16	REMOVED ROUGH-INS	FEB 5, 2025	·
DRAWING NAME -	17	ISSUED FOR CONST.	APR 1, 2025	PAGE 14 OF 16
TYPICAL DETAILS	18	REMOVED WET BARS	APR 28, 2025	
4.50	19	FDN. REVISIONS	JUL. 21, 2025	
SCALE: 1/2" = 1'-0"	20	ADDED BASEMENT UNITS	AUG 12, 2025	

### PROJECT NOTES -


- 1. FIRE SEPARATION PENETRATIONS MUST BE SEALED, TIGHTLY FITTED, FIRE STOPPED OR CONFIGURED TO MAINTAIN THE INTEGRITY OF THE SEPARATION AS PER NBCC 2015, SECTION 9.10.9.6 & 9.10.9.7
- 2. STAIRWELL HANDRAILS REQUIRE 12" HORIZONTAL PROJECTION BEYOND LAST TREAD ONE ONE SIDE OF STAIRS
- 3. PLACEMENT OF PLUMBING FIXTURES IN THE MECHANICAL ROOM MUST MEET APPLICABLE ELECTRICAL CODE & STANDARDS
- 4. SMOKE ALARMS TO CONFORM TO NBCC SUBSECTION 9.10.19

### ADAPTABILITY NOTES -

- MAIN UNIT ENTRANCE DOORS SHALL BE EASILY ACCESSED AND BE CAPABLE OF BEING MADE BARRIER FREE FROM PARKING AREA OR SIDEWALK IN ORDER TO COMPLY WITH ADAPTABLE HOUSING REQUIREMENTS
- 2. ALL UNITS TO COMPLY WITH ADAPTABLE HOUSING REQUIREMENTS (AHR)
- 3. ALL UNIT ENTRANCE DOORS SHALL BE LOW THRESHOLD (MAX 1/2") & BE EQUIPPED WITH HARDWARE CONFORMING TO AHR
- 4. ALL UNIT INTERIOR DOORS SHALL BE EQUIPPED WITH DOOR OPENING HARDWARE CONFORMING TO AHR
- 5. KITCHEN CONTROLS, PLUMBING & ELECTRICAL TO CONFORM WITH AHR
- 6. BATHROOM CONTROLS & HARDWARE SHALL CONFORM TO AHR
- 7. WALL ASSEMBLIES ENCLOSING BATHROOM TO INCLUDE REINFORCEMENT TO ALLOW FUTURE INSTALLATION OF GRAB BARS CONFORMING TO AHR

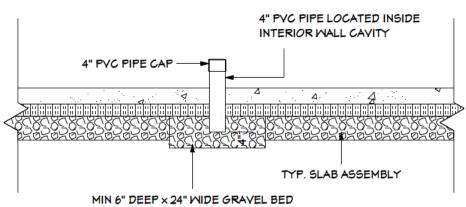

2x6 P.T. BOTTOM PLATE ANCHORED TO CURB MALL MITH 1/2" × 8" ANCHOR BOLTS @ 48" OC TYP INSULATED FOUNDATION SILL WALL ASSEMBLY - SEE GASKET SECTION A12 DAMPPROOFING MEMBRANE ON EXTERIOR OF CONCRETE WALL BELOW GRADE TYP SLAB 1" XPS RIGID **ASSEMBLY** INSUL. (R5) APPROX GRADE CRUSHED STONE 2" XPS RIGID INSUL. (R10) -8" × 18" CONCRETE FOOTING 4" DIAM. PERIMETER DRAIN TILE

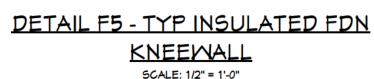

BUILT-UP
BEAM (SIZE &
PLIES VARY)

BEAM TO POST TIE-DOWN

SIMPSON STRONG-TIE POST
BASE OR CARPORT BRACKET

10" CONCRETE
FILLED SONOTUBE


28" DIAM. BIGFOOT

# TYPICAL SONOTUBE / BEAM DETAIL

SCALE: 1/2" = 1'-0"

# SOIL GAS ROUGH-IN DETAIL

SCALE: 1/2" = 1'-0'

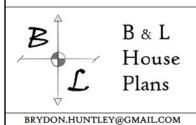

### GENERAL NOTES -

. BUILDER QUALIFICATIONS -

THIS PLAN IS INTENDED FOR USE BY PERSONS KNOWLEDGEABLE IN AND FAMILIAR WITH GENERALLY ACCEPTED METHODS, TECHNIQUES AND STANDARDS NECESSARY FOR THE CONSTRUCTION OF THIS STRUCTURE.

2. BUILDING CODES -

- ALL WORK TO BE COMPLETED IN ACCORDANCE WITH THE CURRENT NATIONAL BUILDING CODE OF CANADA.

- ALL FEDERAL, PROVINCIAL AND LOCAL ORDINANCES, ETC., SHALL BE CONSIDERED AS SPECIFICATIONS FOR THIS STRUCTURE AND SHALL TAKE PRECEDENCE OVER ANYTHING SHOWN, DESCRIBED OR IMPLIED, IF AND WHERE VARIANCES OCCUR

OCCUR.

- IN THE CASE OF HIGH SNOW LOADS OR UNUSUAL
SITE CONDITIONS, NON-STANDARD FOUNDATIONS OR
BEAM SIZES BEYOND THE SCOPE OF NBC PART 9
TABLES, THE OWNER / BUILDER MAY BE REQUIRED
TO PROVIDE AT THEIR EXPENSE, AN ENGINEER'S
REPORT. PLEASE CONSULT WITH LOCAL BUILDING

AUTHORITIES.


3. ERRORS AND OMISSIONS –
GREAT CARE HAS BEEN TAKEN IN THE
PRODUCTION OF PLANS FOR THIS PROJECT, BUT
THERE ALWAYS EXISTS THE SMALL POSSIBILITY
FOR ERRORS. IT IS VERY IMPORTANT THAT THE
BUILDER CAREFULLY REVIEW & CHECK ALL
DETAILS AND INFORMATION ON THIS PLAN
INCLUDING DIMENSIONING PRIOR TO
PROCEEDING WITH CONSTRUCTION.
RESPONSIBILITY MUST LIE WITH THE BUILDER.
HOWEVER, ANY ERRORS OR OMISSIONS FOUND
SHOULD BE REPORTED IMMEDIATELY TO B&L
HOUSE PLANS PRIOR TO CONSTRUCTION.

4. B&L HOUSE PLANS SHALL NOT BE RESPONSIBLE FOR EXISTING SITE CONDITIONS SUCH AS SOIL BEARING CAPACITY, WATER TABLE, BURIED STRUCTURES, OR PROXIMITY TO PROPERTY LINES.

5. CARBON MONOXIDE DETECTORS TO BE INSTALLED ON EACH LEVEL ADJACENT TO BEDROOMS AND WHERE PROPANE FIREPLACE, GAS AND WOOD BURNING APPLIANCES ARE USED.

6. ALL DRAWINGS REMAIN THE PROPERTY OF 'B&L HOUSE PLANS'

PROJECT NAME -		ON TABLE -	SHEET:	
EVERGREEN PHASE 1 10 UNIT APT BLDG (UNITS 4-8)	REV#	REVISION	DATE	
10 01/11 11 1 222 0 (01/110 1 0)	16	REMOVED ROUGH-INS	FEB 5, 2025	•
DRAWING NAME -	17	ISSUED FOR CONST.	APR 1, 2025	<b>PAGE 15 OF 16</b>
TYPICAL DETAILS, NOTES	18	REMOVED WET BARS	APR 28, 2025	
	19	FDN. REVISIONS	JUL. 21, 2025	
SCALE: 1/2" = 1'-0"	20	ADDED BASEMENT UNITS	AUG 12, 2025	

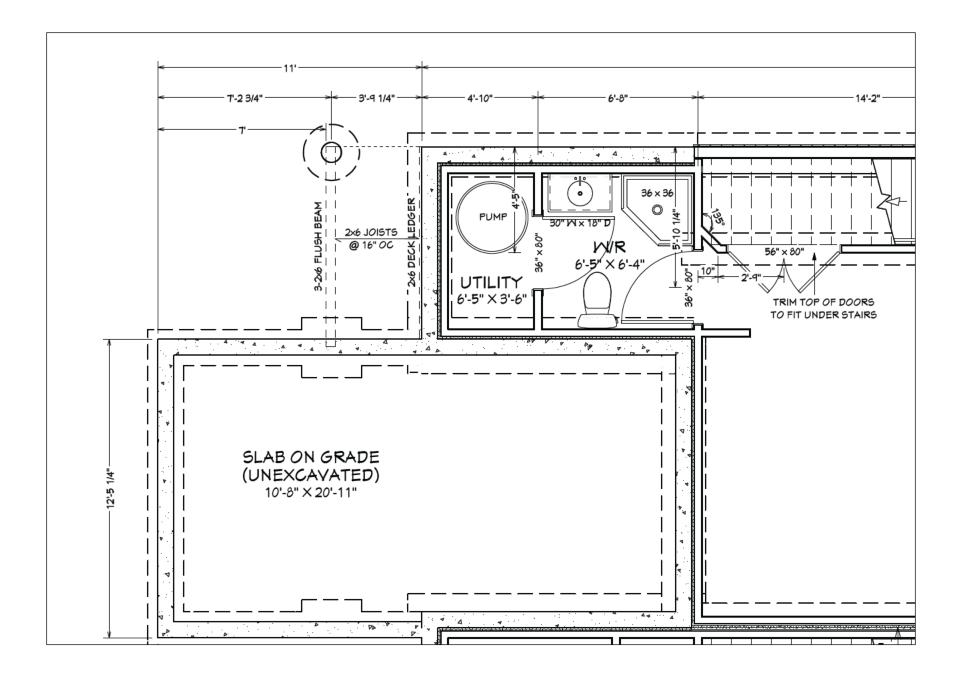



 BUILDER QUALIFICATIONS THIS PLAN IS INTENDED FOR USE BY PERSONS
KNOWLEDGEABLE IN AND FAMILIAR WITH GENERALLY
ACCEPTED METHODS, TECHNIQUES AND STANDARDS NECESSARY FOR THE CONSTRUCTION OF THIS STRUCTURE.

2. BUILDING CODES –
- ALL WORK TO BE COMPLETED IN ACCORDANCE WITH THE CURRENT NATIONAL BUILDING CODE OF CANADA.

- ALL FEDERAL, PROVINCIAL AND LOCAL ORDINANCES, ETC., SHALL BE CONSIDERED AS SPECIFICATIONS FOR THIS STRUCTURE AND SHALL TAKE PRECEDENCE OVER ANYTHING SHOWN, DESCRIBED OR IMPLIED, IF AND WHERE VARIANCES

OCCUR OCCUR.

- IN THE CASE OF HIGH SNOW LOADS OR UNUSUAL
SITE CONDITIONS, NON-STANDARD FOUNDATIONS OR
BEAM SIZES BEYOND THE SCOPE OF NBC PART 9
TABLES, THE OWNER / BUILDER MAY BE REQUIRED TO PROVIDE AT THEIR EXPENSE, AN ENGINEER'S REPORT. PLEASE CONSULT WITH LOCAL BUILDING AUTHORITIES.

3. ERRORS AND OMISSIONS – GREAT CARE HAS BEEN TAKEN IN THE PRODUCTION OF PLANS FOR THIS PROJECT, BUT THERE ALWAYS EXISTS THE SMALL POSSIBILITY FOR ERRORS. IT IS VERY IMPORTANT THAT THE BUILDER CAREFULLY REVIEW & CHECK ALL BUILDER CAREFULLY REVIEW & CHECK ALL DETAILS AND INFORMATION ON THIS PLAN INCLUDING DIMENSIONING PRIOR TO PROCEEDING WITH CONSTRUCTION. RESPONSIBILITY MUST LIE WITH THE BUILDER. HOWEVER, ANY ERRORS OR OMISSIONS FOUND SHOULD BE REPORTED IMMEDIATELY TO B&L HOUSE PLANS PRIOR TO CONSTRUCTION.

B&L HOUSE PLANS SHALL NOT BE RESPONSIBLE FOR EXISTING SITE CONDITIONS SUCH AS SOIL BEARING CAPACITY, WATER TABLE, BURIED STRUCTURES, OR PROXIMITY TO PROPERTY LINES.

5. CARBON MONOXIDE DETECTORS TO BE INSTALLED ON EACH LEVEL ADJACENT TO BEDROOMS AND WHERE PROPANE FIREPLACE, GAS AND WOOD BURNING APPLIANCES ARE USED.

6. ALL DRAWINGS REMAIN THE PROPERTY OF 'B&L HOUSE PLANS'

PROJECT NAME -	REVISION TABLE -				
EVERGREEN PHASE 1 10 UNIT APT BLDG (UNITS 4-8)	REV#	REVISION	DATE		
DRAWING NAME - UNIT 8 BASEMENT W/R & WET BAR LAYOUT	16	REMOVED ROUGH-INS	FEB 5, 2025		
	17	ISSUED FOR CONST.	APR 1, 2025	ĺ	
	18	REMOVED WET BARS	APR 28, 2025		
SCALE: 1/4" = 1'-0"	19	FDN. REVISIONS	JUL. 21, 2025		
	20	ADDED BASEMENT UNITS	AUG 12, 2025		

SHEET:

PAGE 16 OF 1