








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- 6. ALL DRAWINGS REMAIN THE PROPERTY OF 'B&L HOUSE PLANS'

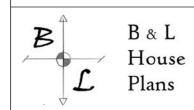

BRYDON.HUNTLEY@GMAIL.COM

PROJECT NAME -

EVERGREEN PHASE 1 6 UNIT APT. BLDG

DRAWING NAME -

3D PERSPECTIVES

	•	COMBO SMOKE & CARBON MONOXIDE ALARM
	\oplus	SMOKE ALARM

LEGEND

•	CARBON MONOXIDE ALARM
l	

S 6	SOIL GAS ROUGH-IN
	56 ©

REV#	REVISIO	N	DATE
2	ISSUED FOR REVIEW		NOV 21, 202
3	ISSUED FOR CONST.		JAN 7, 2025
4	PATIO DOOR S	SIZE	JAN 22, 2025
5	ISSUED FOR P	ERMIT	APR 4, 2025
6	EGRESS WINDOWS, 5/8" DENSGLASS, ROOF VENTS		APR 16, 202
7	MISC CHANGES		APR 24, 202
8	REMOVED WI	ET BAR	APR 28, 202
9	FDN. REVISIONS ADDED 3 UNITS		JUL 21, 2025
10			AUG 13, 202

1/4'' = 1' PAGE 1 OF 13

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BRYDON.HUNTLEY@GMAIL.COM

PROJECT NAME -

EVERGREEN PHASE 1 6 UNIT APT. BLDG

DRAWING NAME -

SITE PLAN

•	COMBO SMOKE & CARBON MONOXIDE ALARM

LEGEND

CARBON MONOXIDE ALARM

SMOKE ALARM

SG SOIL GAS ROUGH-IN

REVIS	ION TABLE -	
REV#	REVISION	DATE
2	ISSUED FOR REVIEW	NOV 21, 20
3	ISSUED FOR CONST.	JAN 7, 202

2	ISSUED FOR REVIEW		NOV 21, 2024
3	ISSUED FOR CONST.		JAN 7, 2025
4	PATIO DOOR SIZE ISSUED FOR PERMIT EGRESS WINDOWS, 5/8" DENSGLASS, ROOF VENTS		JAN 22, 2025
5			APR 4, 2025
6			APR 16, 2025
7	MISC CHANG	GES	APR 24, 2025
8	REMOVED WET BAR FDN. REVISIONS ADDED 3 UNITS		APR 28, 2025
9			JUL 21, 2025
10			AUG 13, 2025
SCALI	E: SHEET:		

1/16'' = 1' PAGE 2 OF 13

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BRYDON.HUNTLEY@GMAIL.COM

PROJECT NAME

EVERGREEN PHASE 1 6 UNIT APT. BLDG

DRAWING NAME -

FRONT ELEVATION

LEGEND

•	COMBO SMOKE & CARBON MONOXIDE ALARM
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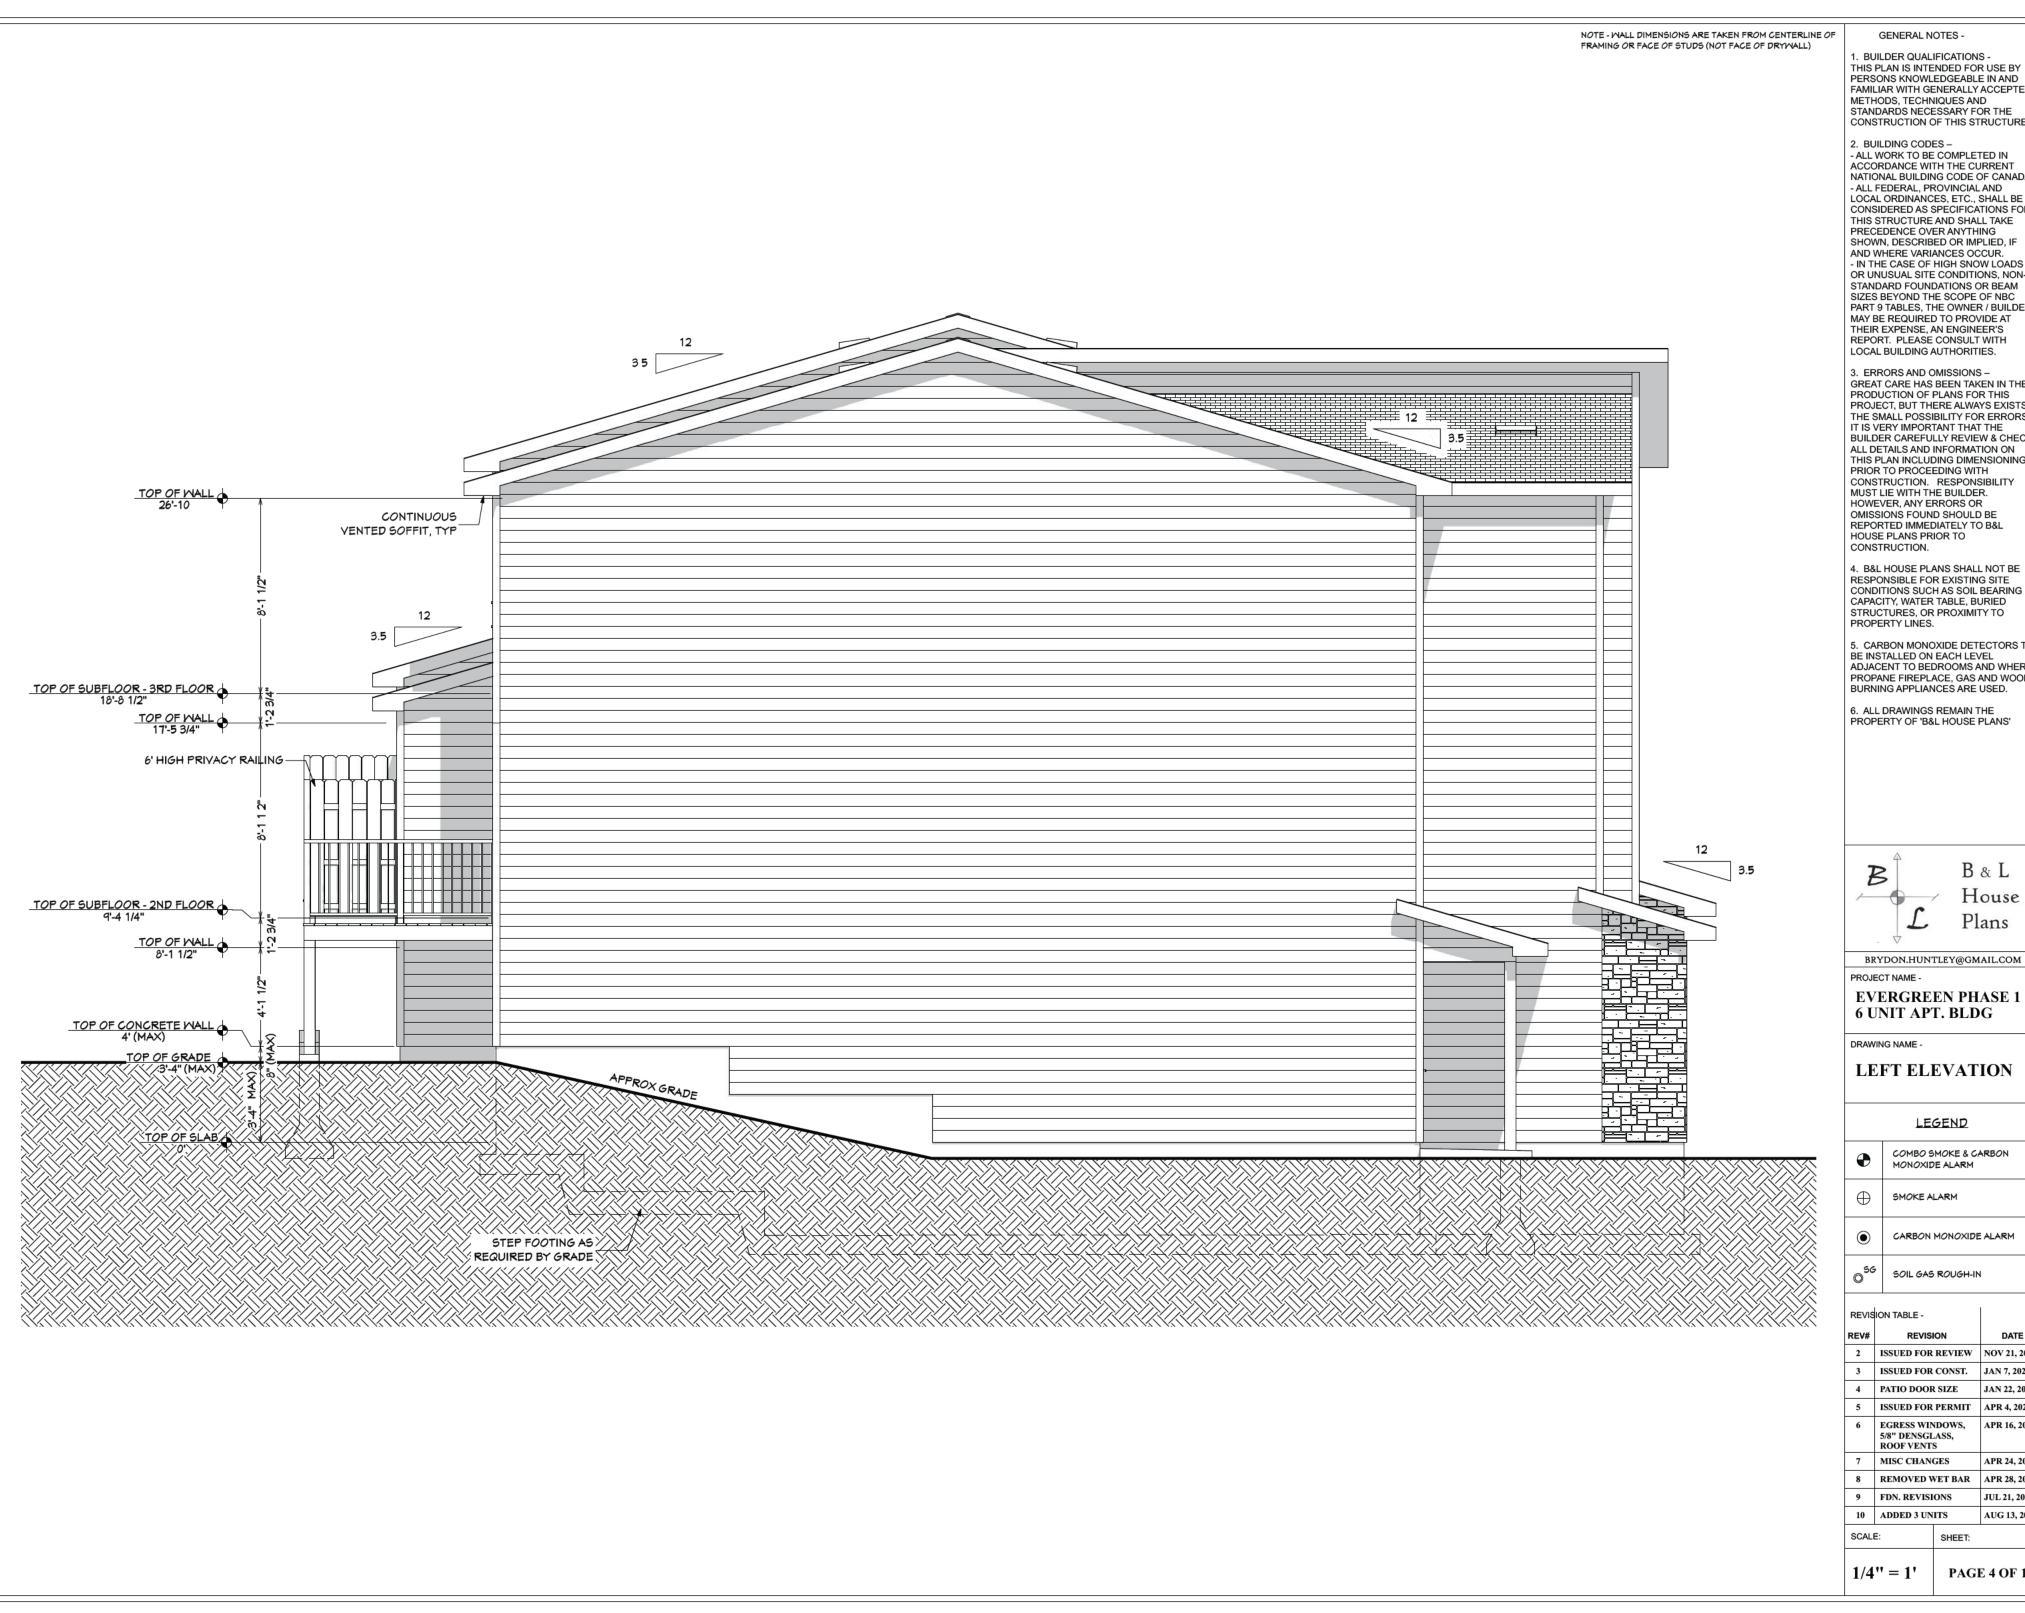
SMOKE ALARM

CARBON MONOXIDE ALARM

SOIL GAS ROUGH-IN

REVIS	ION TABLE -		
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10	ADDED 3 UNITS		AUG 13, 2025
SCALE:		SHEET:	

PAGE 3 OF 13



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EVERGREEN PHASE 1 6 UNIT APT. BLDG

DRAWING NAME -

LEFT ELEVATION

LEGEND

COMBO SMOKE & CARBON MONOXIDE ALARM

SMOKE ALARM

CARBON MONOXIDE ALARM

SOIL GAS ROUGH-IN

REVIS	REVISION TABLE -				
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SCALI	F:	SHEET:			

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EVERGREEN PHASE 1 6 UNIT APT. BLDG

REAR ELEVATION

LEGEND


•	COMBO SMOKE & CARBON MONOXIDE ALARM	

SMOKE ALARM

CARBON MONOXIDE ALARM

SOIL GAS ROUGH-IN

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EVERGREEN PHASE 1 6 UNIT APT. BLDG

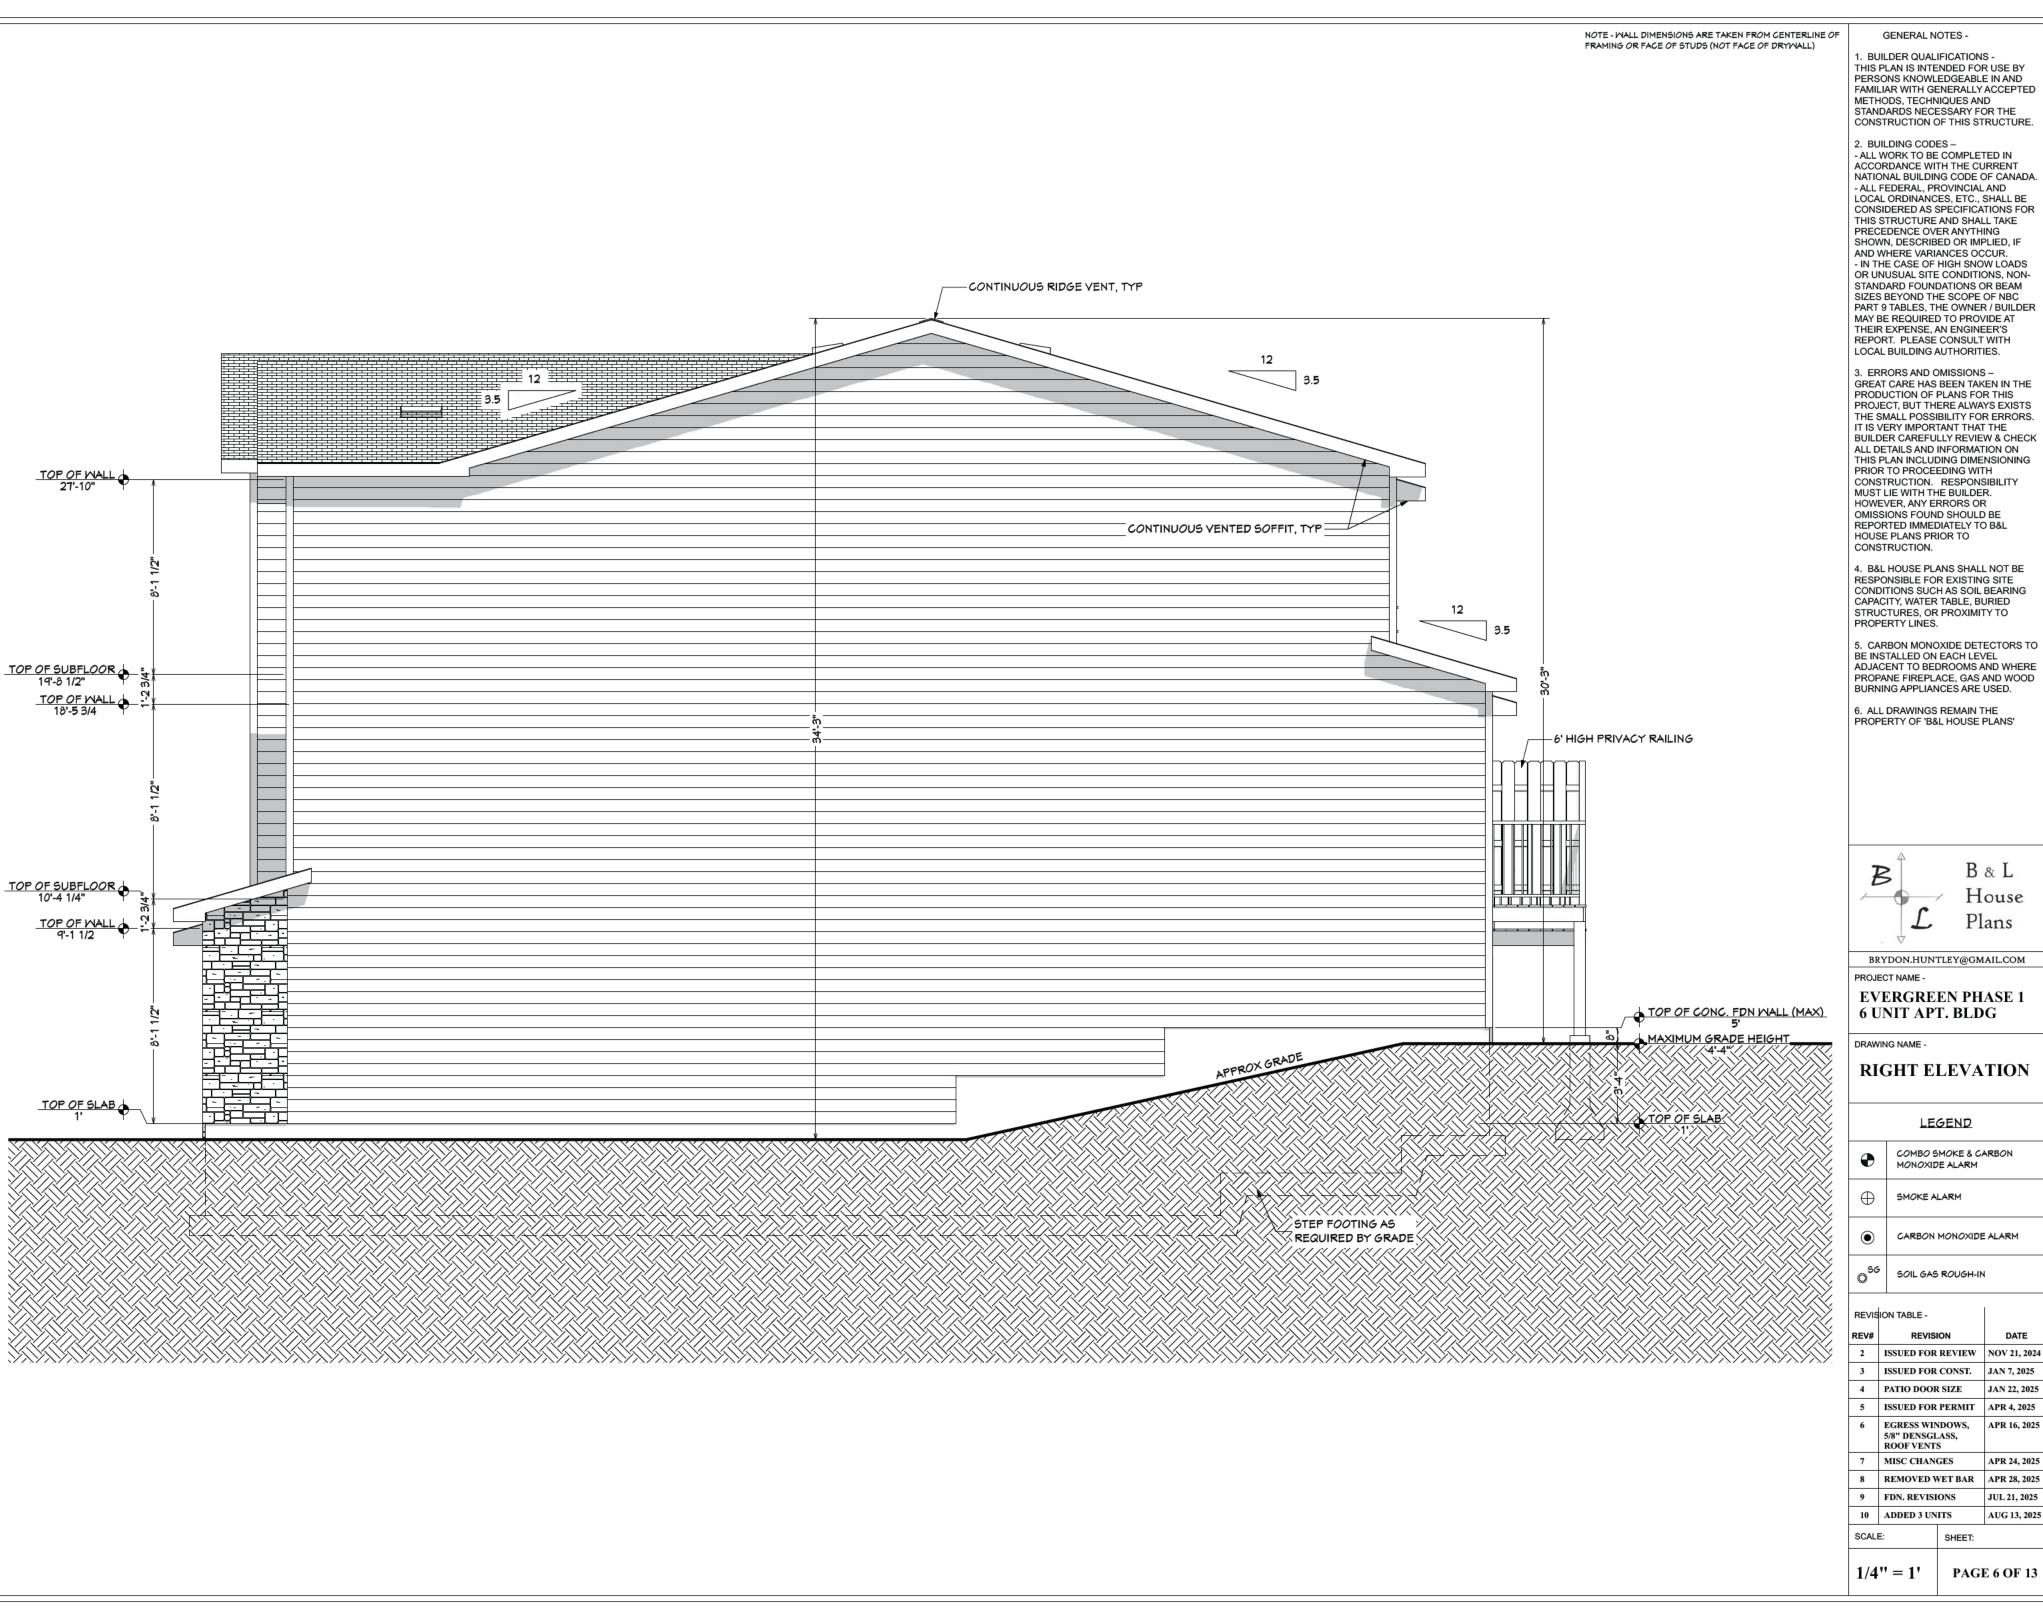RIGHT ELEVATION

LEGEND

BON

SMOKE ALARM

CARBON MONOXIDE ALARM


SOIL GAS ROUGH-IN


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5/8" DENSGLASS, ROOF VENTS	5	ISSUED FOR PERMIT	APR 4, 2025
7 MISC CHANGES APR 24, 2025	6	5/8" DENSGLASS,	APR 16, 2025
	7	MISC CHANGES	APR 24, 2025


PAGE 6 OF 13


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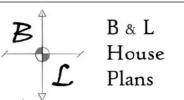




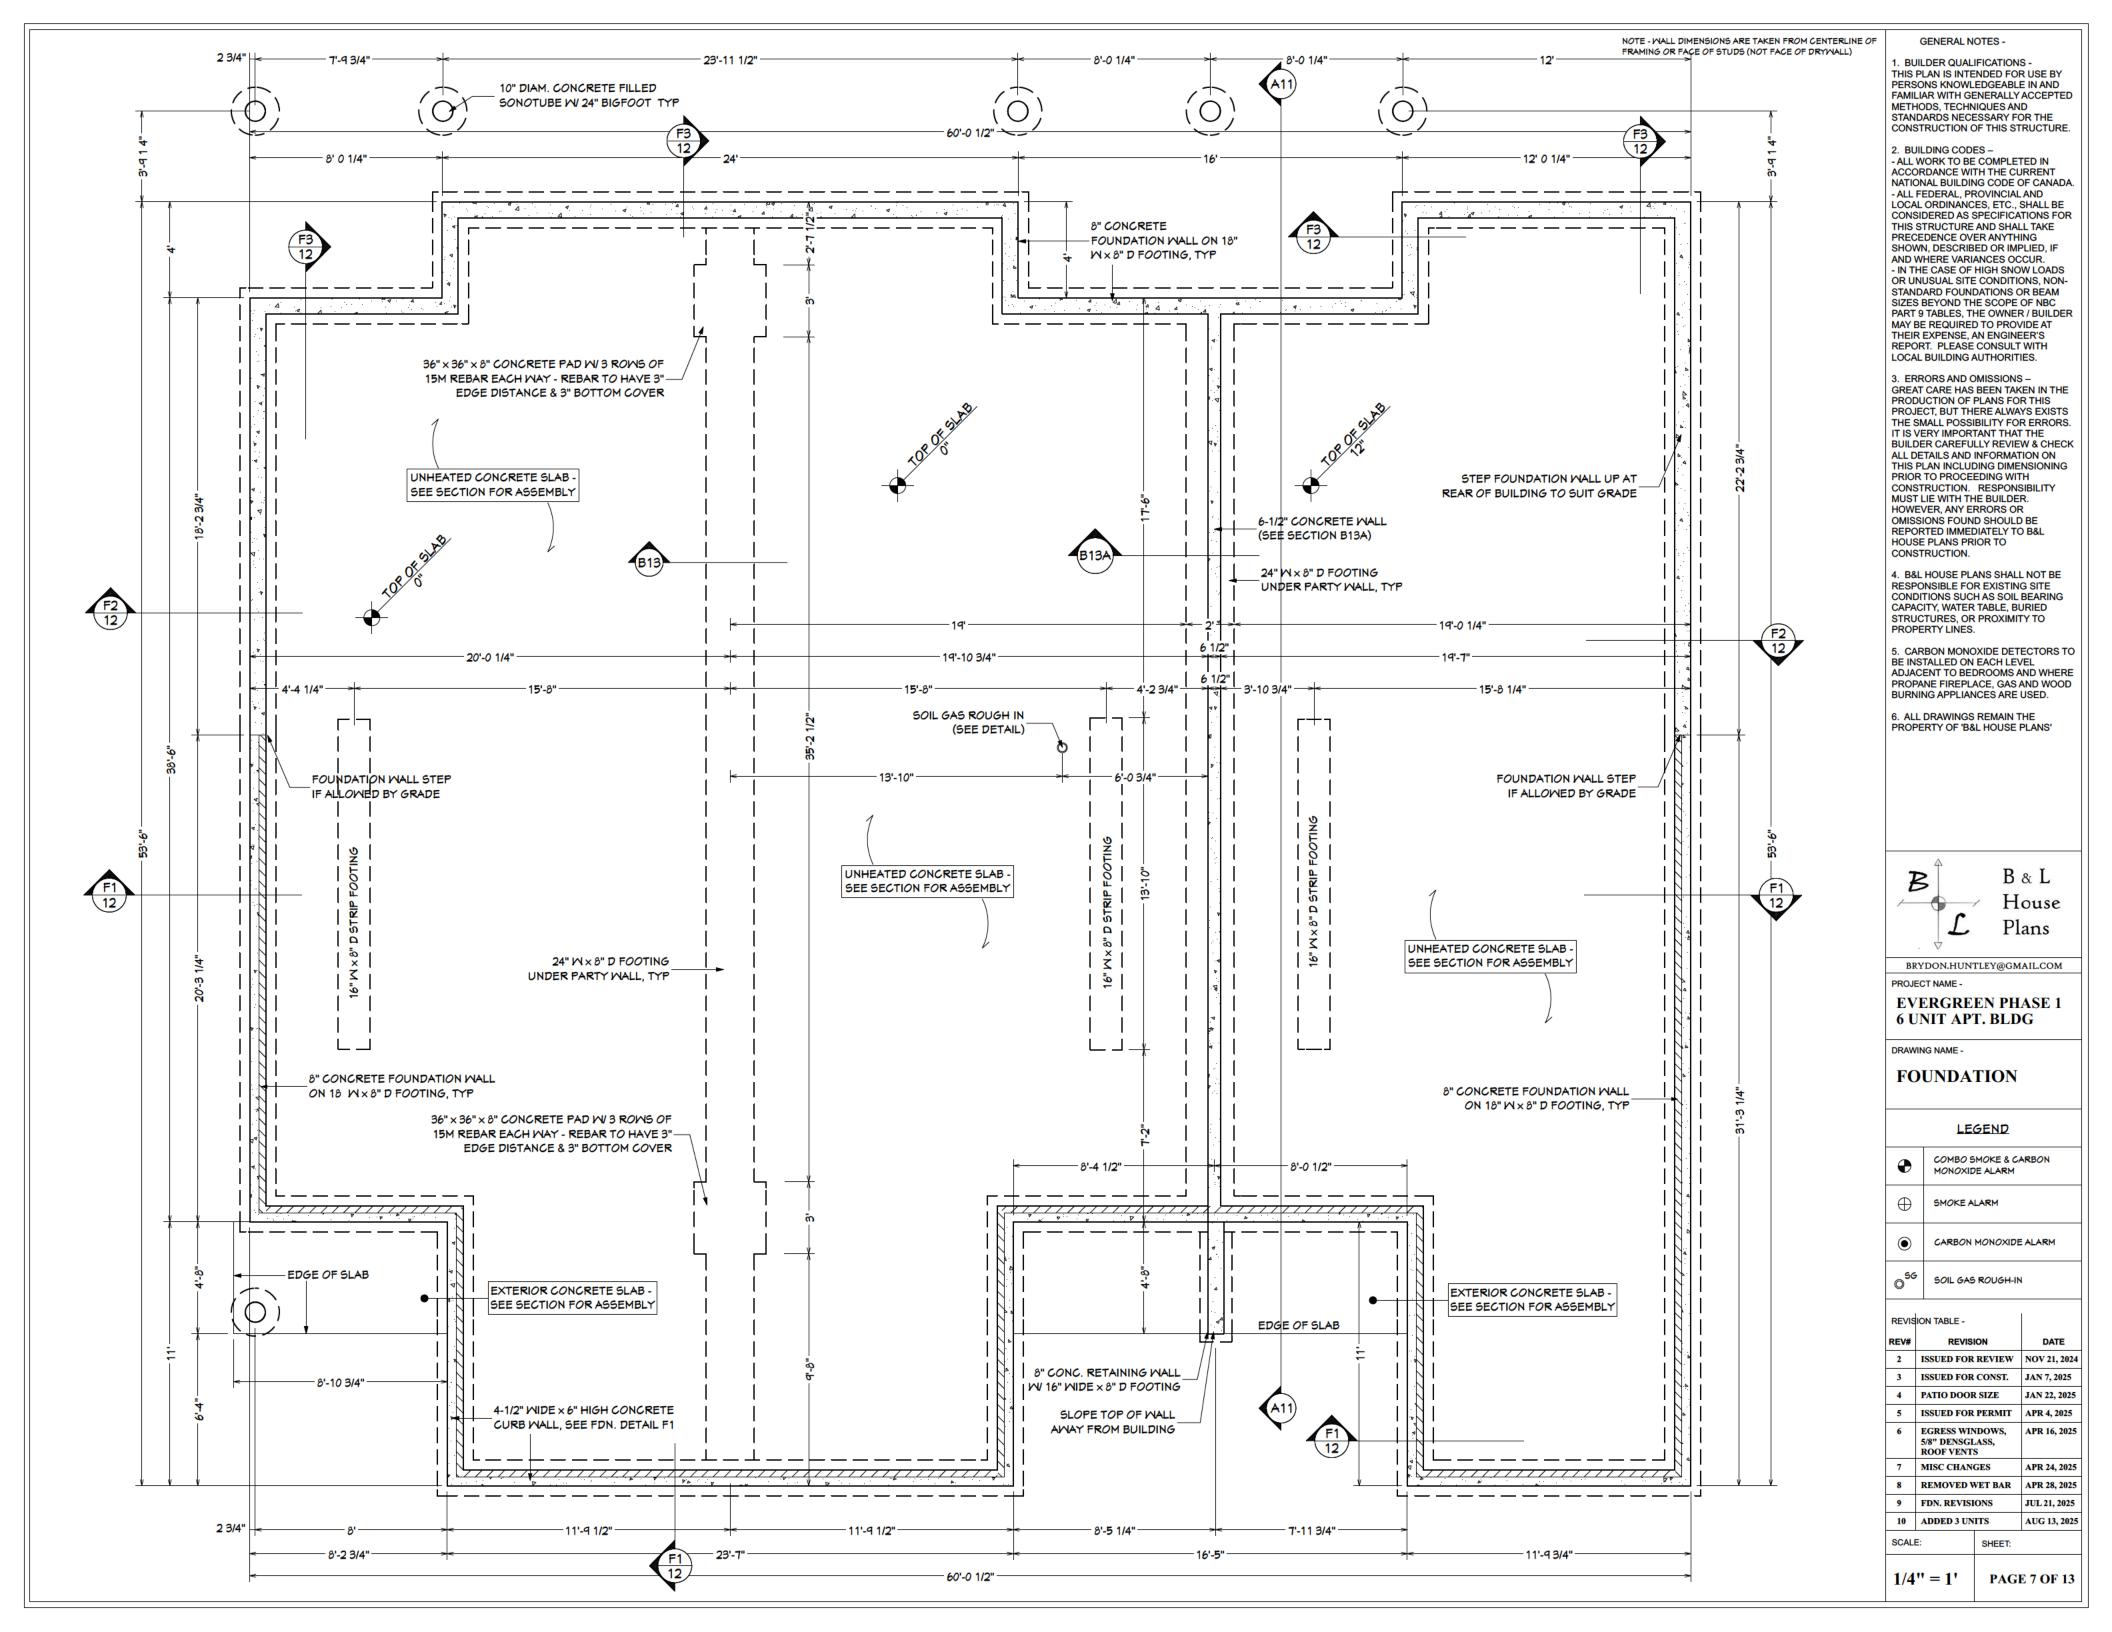

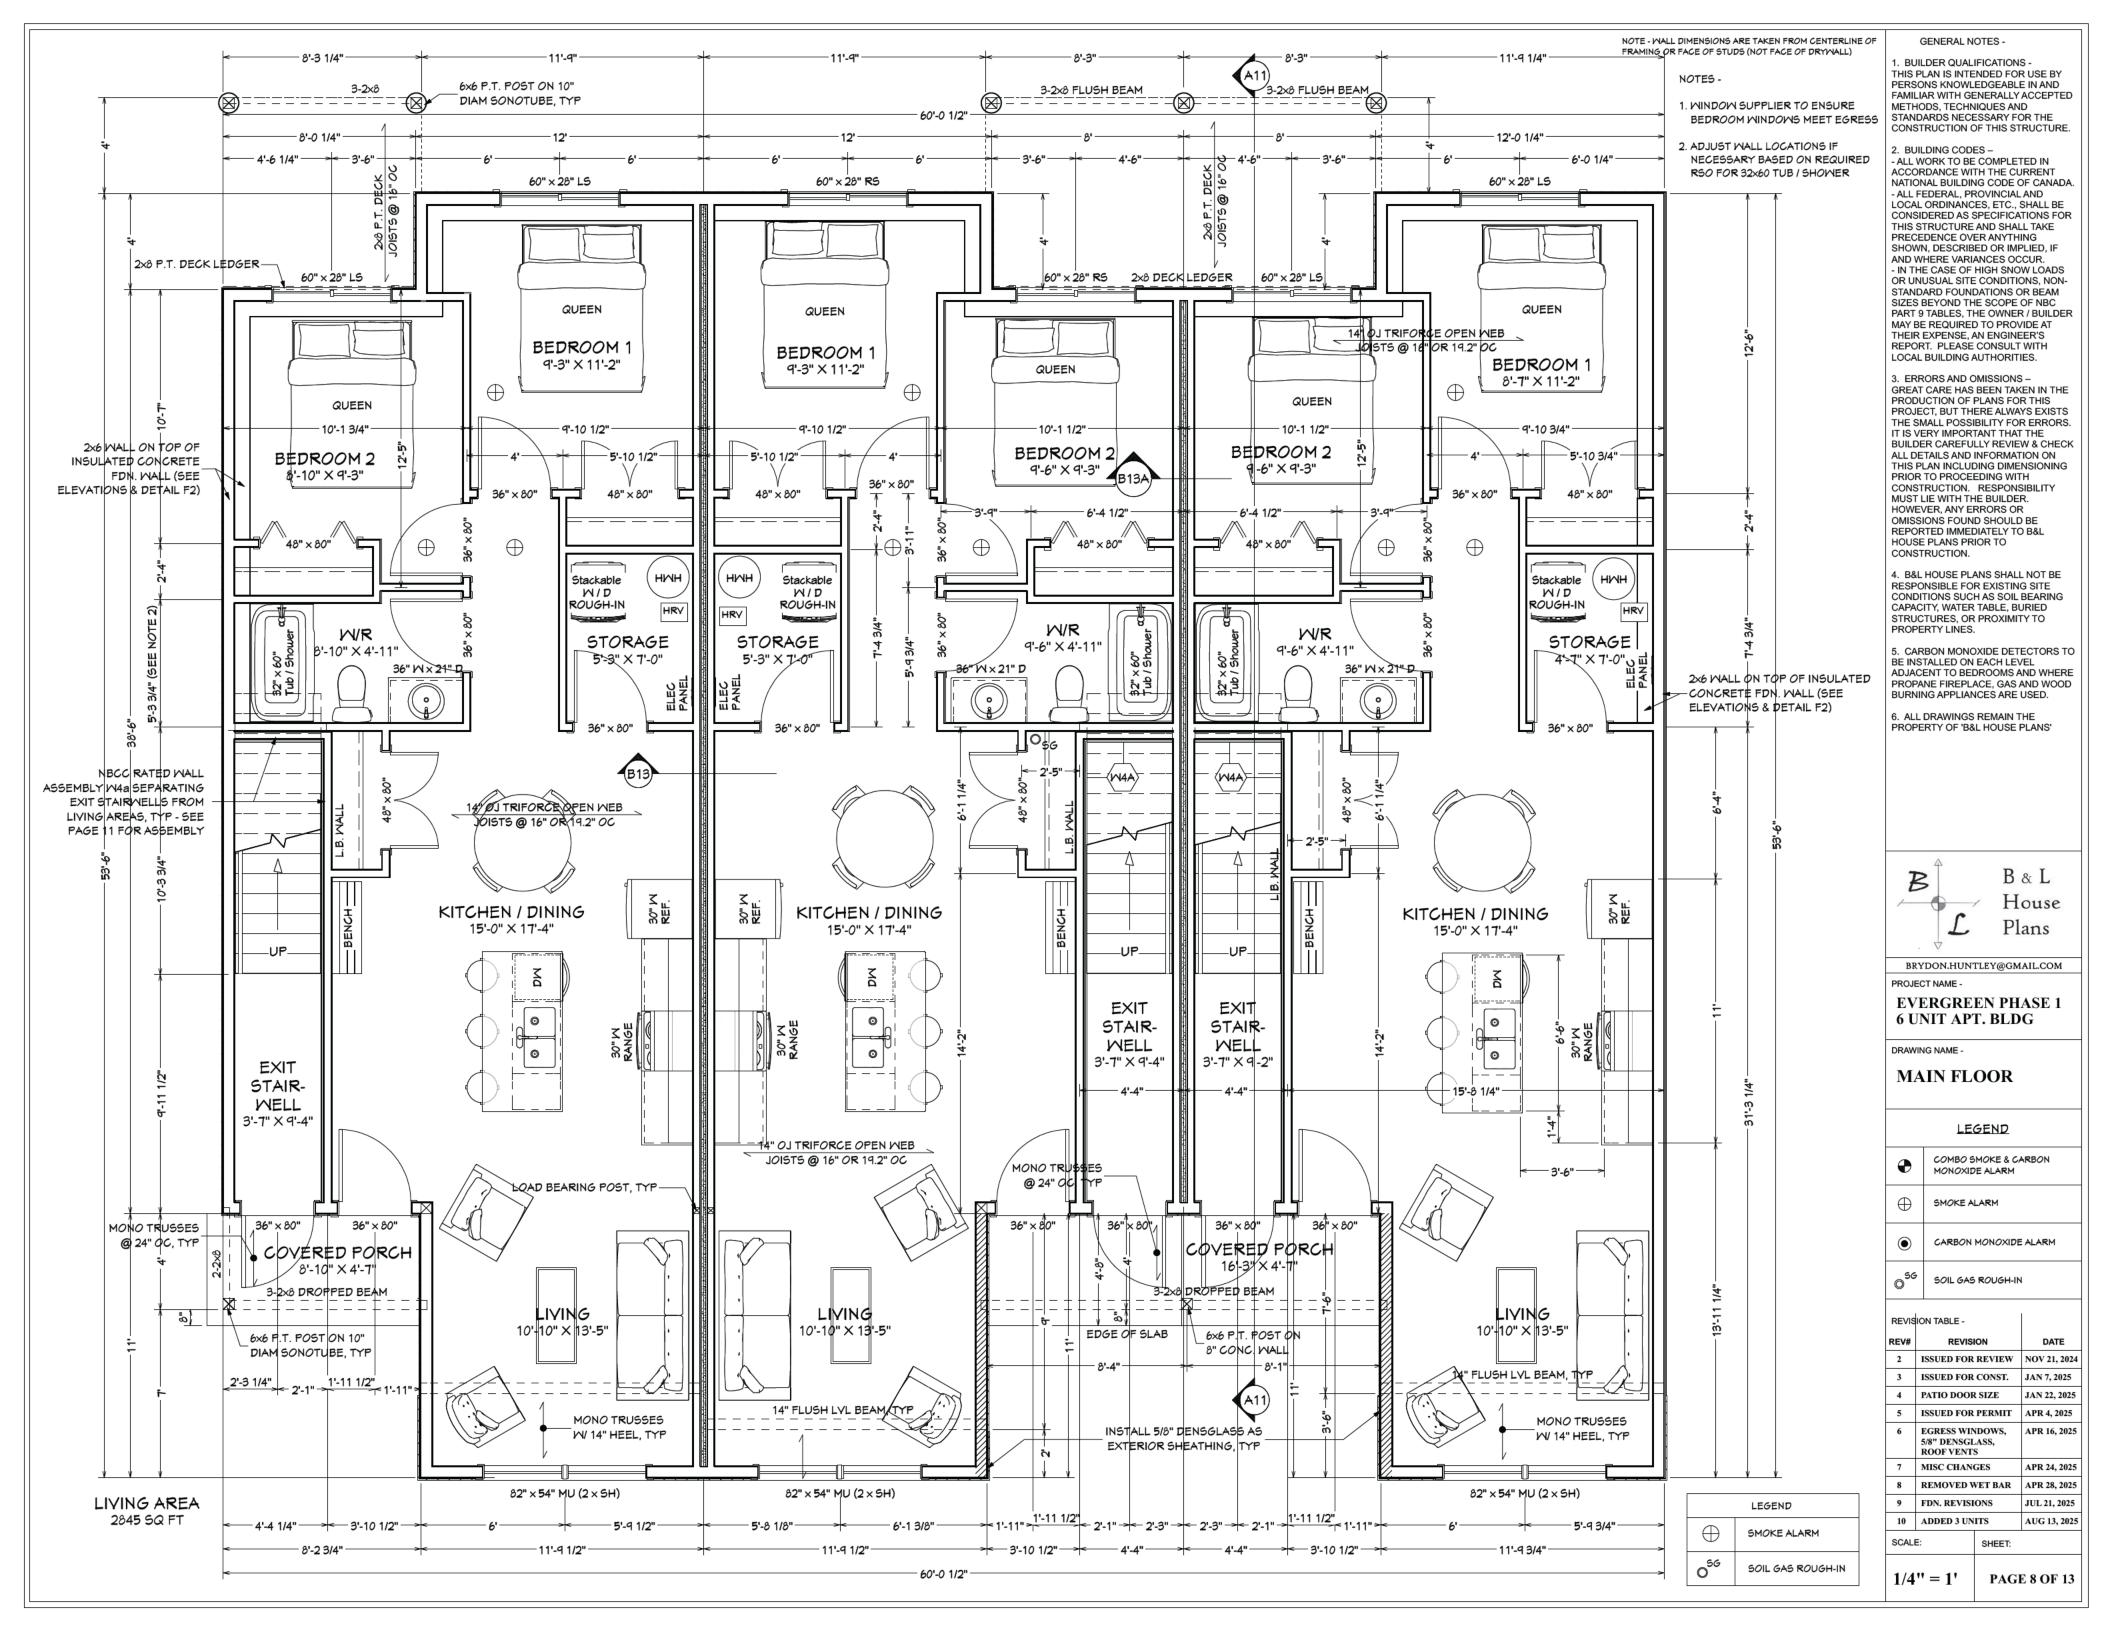
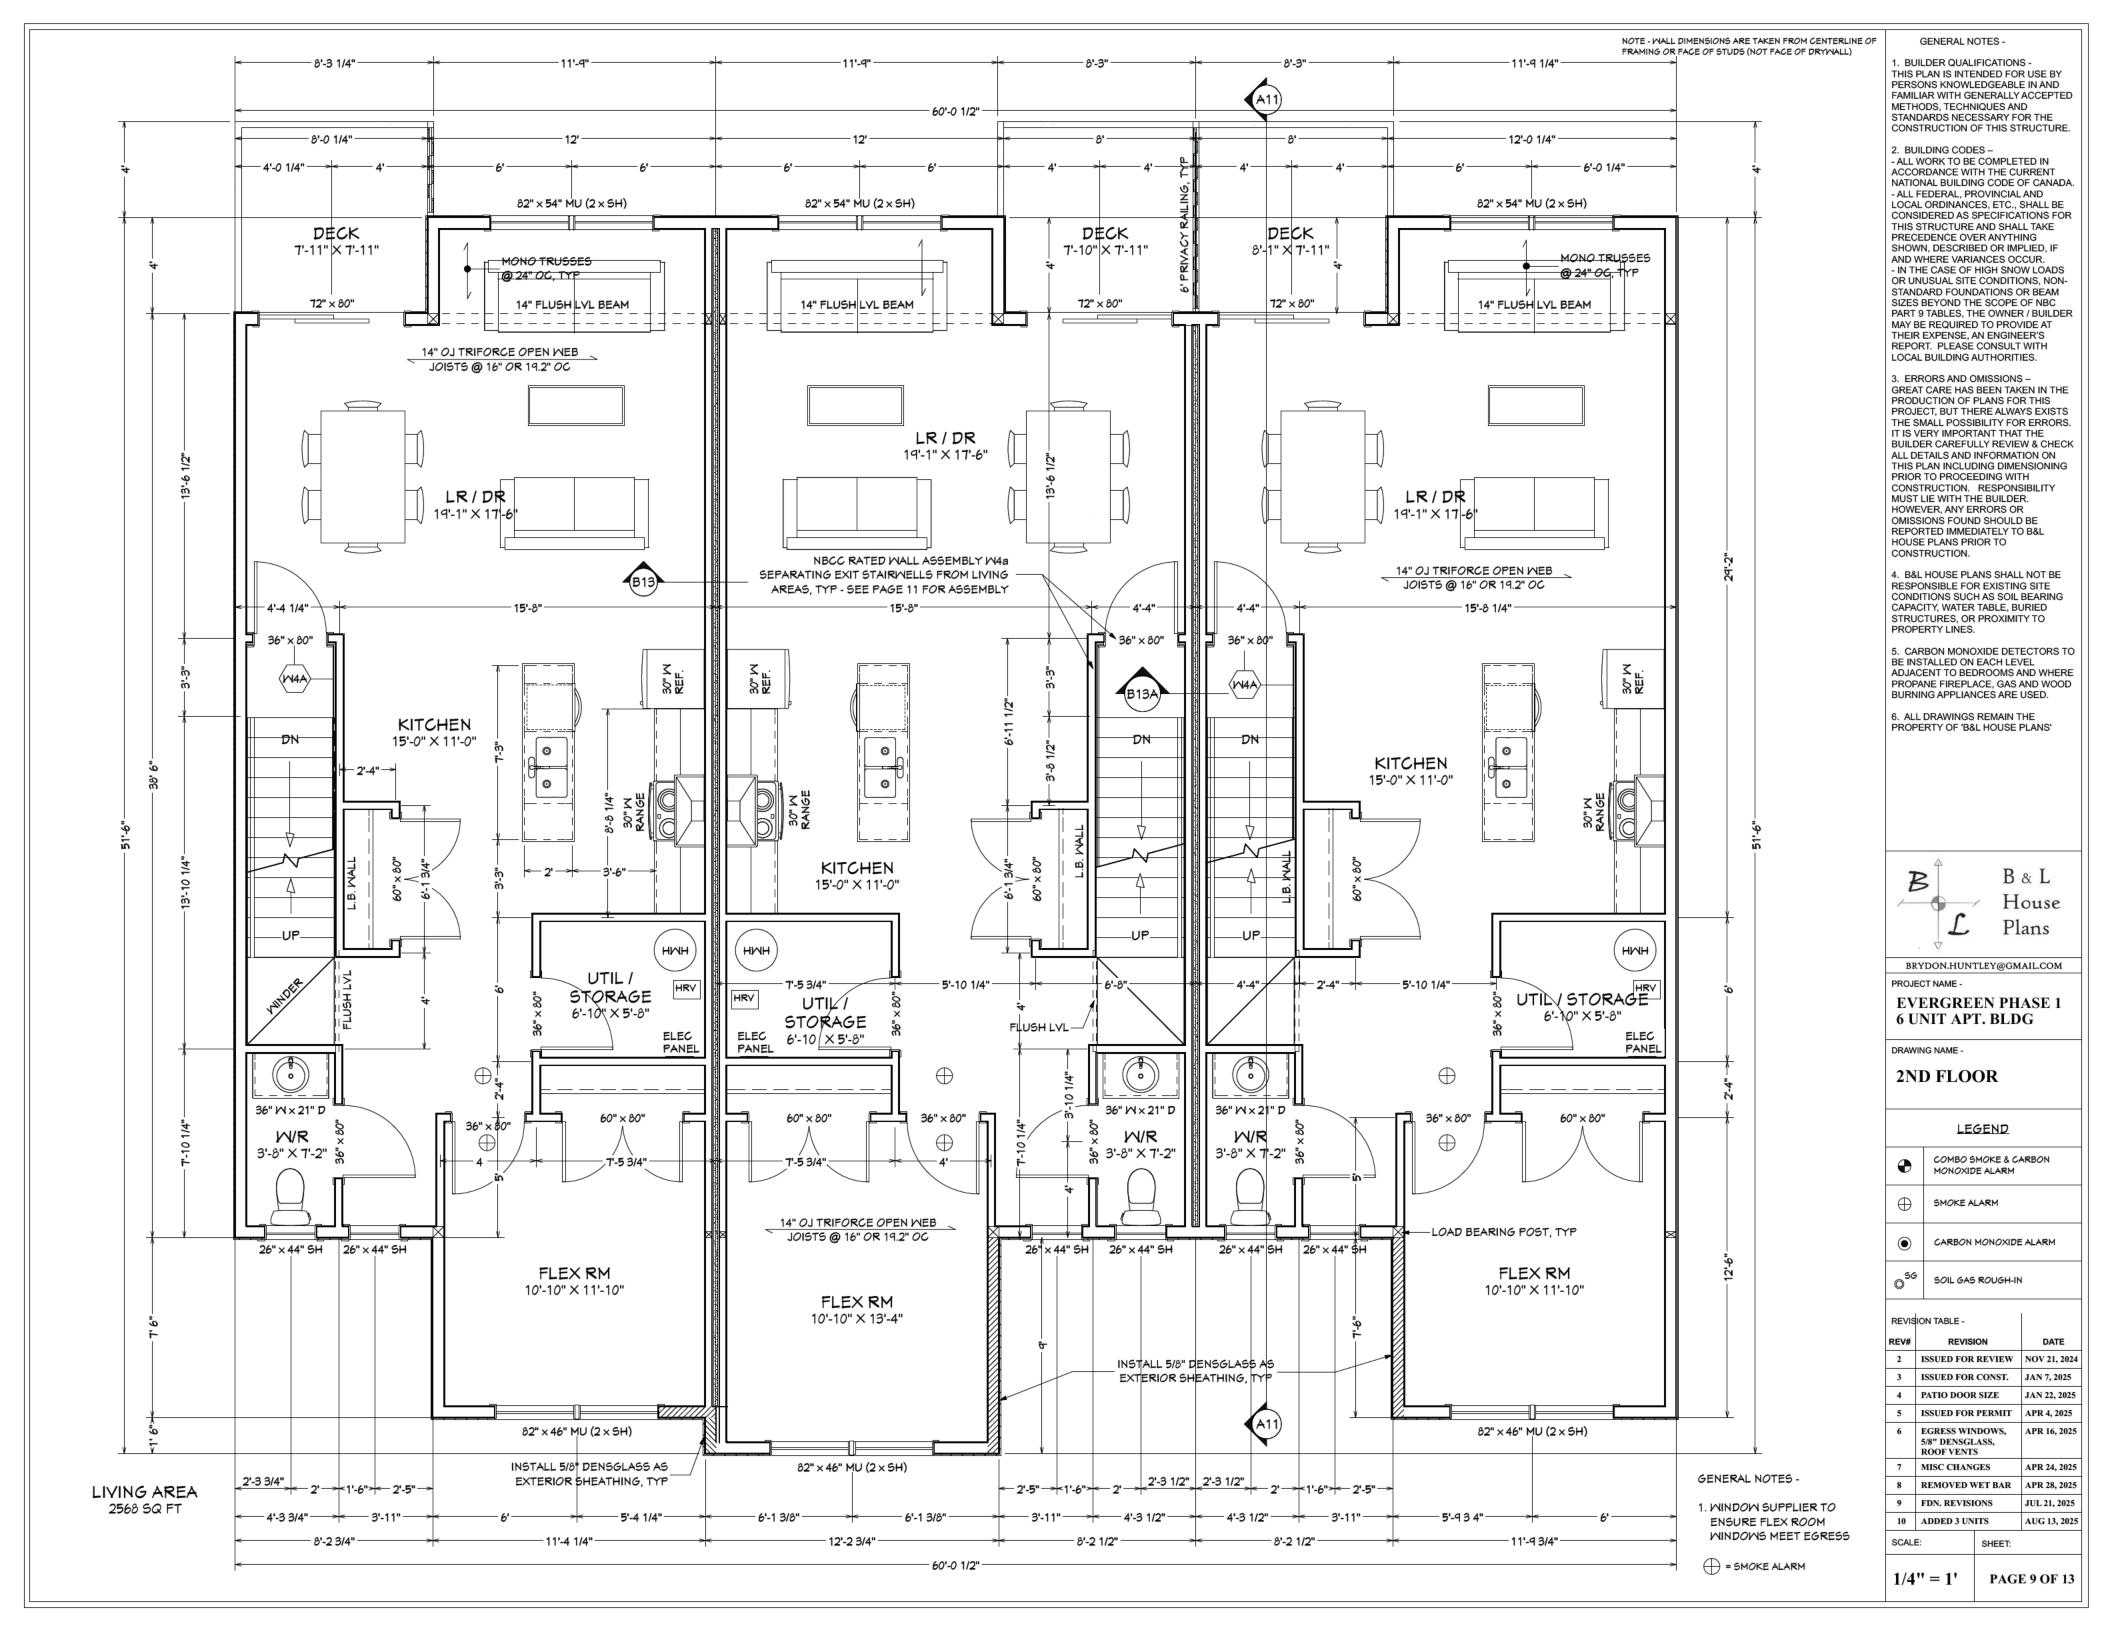
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EVERGREEN PHASE 1 6 UNIT APT. BLDG

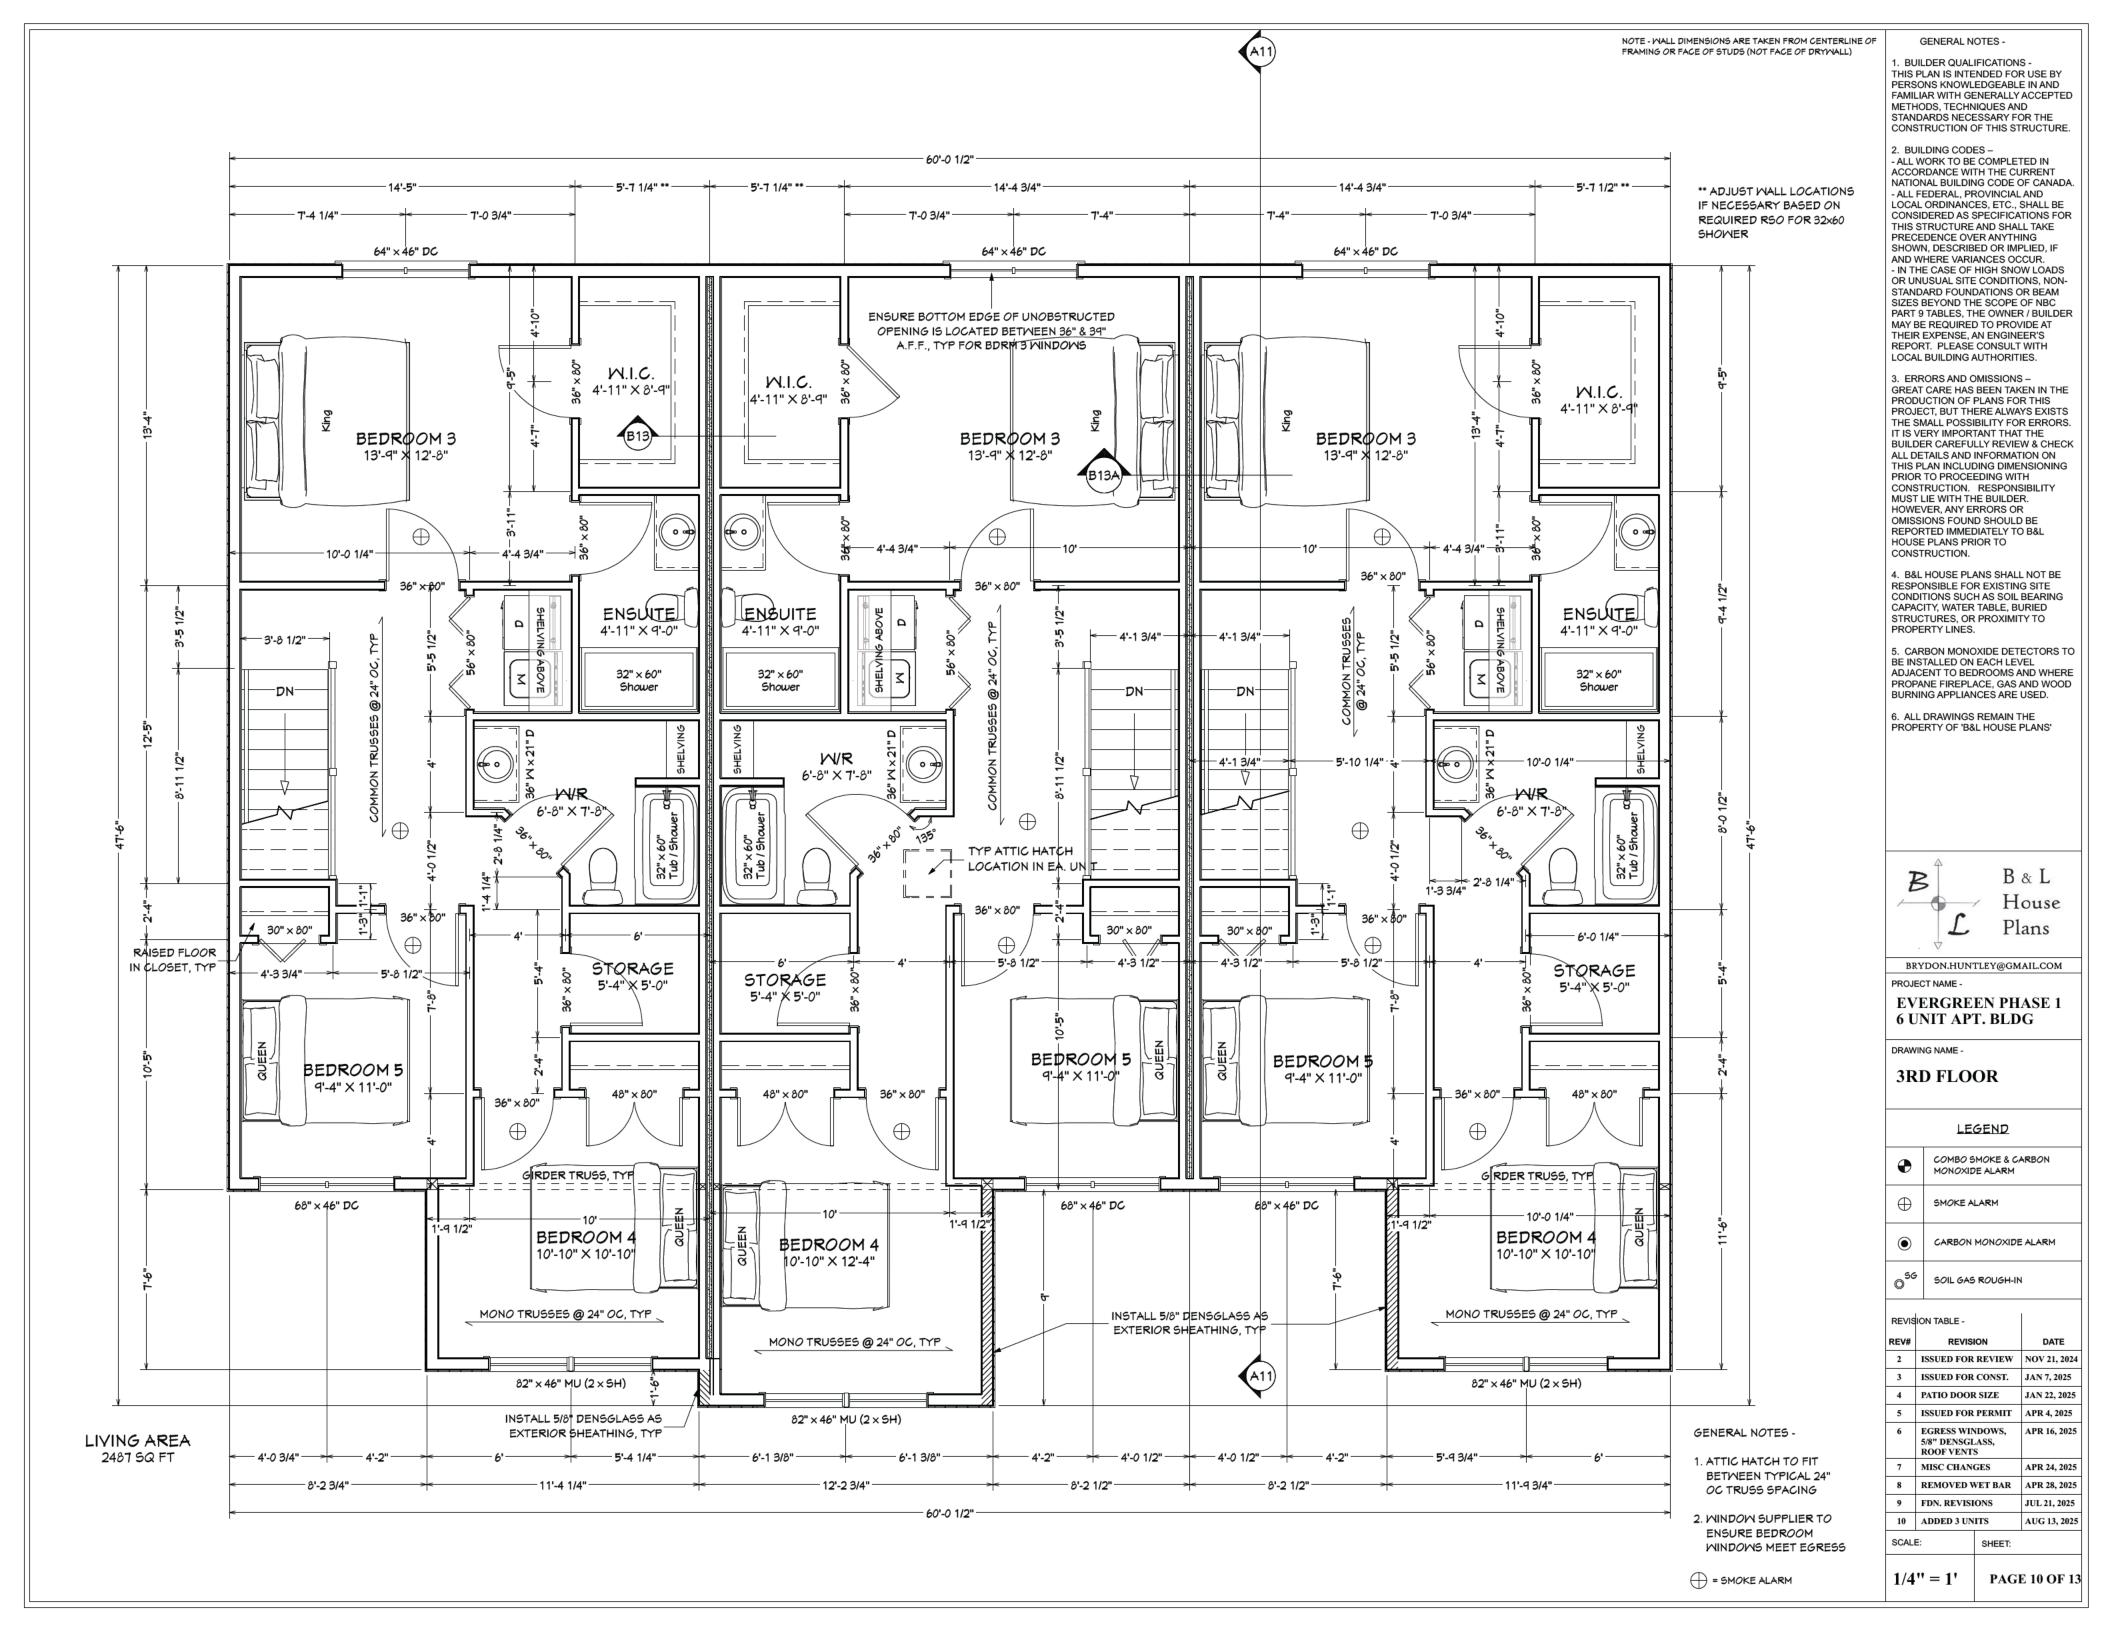DRAWING NAME -

SECTION A11

LEGEND

COMBO SMOKE & CARBON MONOXIDE ALARM

SMOKE ALARM


CARBON MONOXIDE ALARM

SOIL GAS ROUGH-IN

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SHEET:


PAGE 11 OF 13

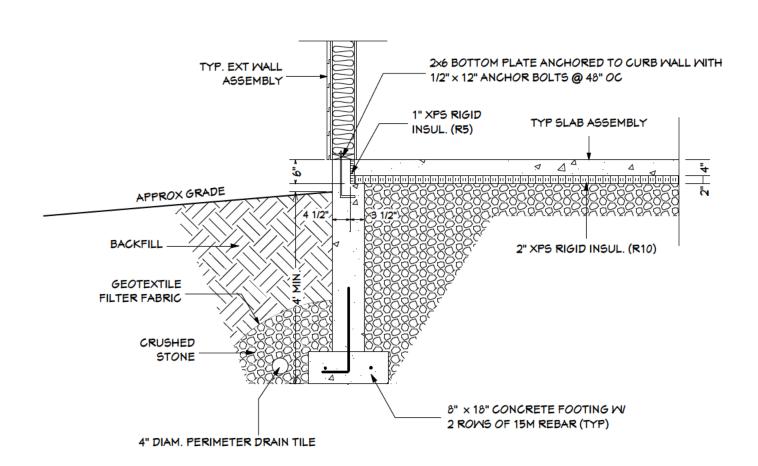


FOUNDATION DETAIL F1 - TYP. FOUNDATION WALL SCALE: 1/2" = 1'-0"

TYP. CONC. FDN. KNEEWALL (ABOVE SLAB) 2x6 P.T. BOTTOM PLATE 8" CONCRETE WALL W/ DAMPPROOFING BELOW GRADE ANCHORED TO CURB WALL WITH 1-1/2" YAPOR RETARDANT XPS RIGID INSULATION (R7.5) 1/2" × 8" ANCHOR BOLTS @ 48" OC 2x4 SPF STUDS @ 16" OC R12 BATT INSULATION 6 MIL POLY VAPOR BARRIER SILL GASKET 1/2" REGULAR DRYWALL DAMPPROOFING MEMBRANE TYP SLAB ON EXTERIOR OF CONCRETE ASSEMBLY 1" XPS RIGID MALL BELOW GRADE INSUL. (R5) APPROX GRADE **BACKFILL GEOTEXTILE** 2" XPS RIGID FILTER FABRIC INSUL. (R10) CRUSHED STONE 8" × 18" CONCRETE FOOTING W 2 ROWS OF 15M REBAR (TYP) 4" DIAM. PERIMETER DRAIN TILE

FOUNDATION DETAIL F2 CONCRETE KNEEWALL SCALE: 1/2" = 1'-0"

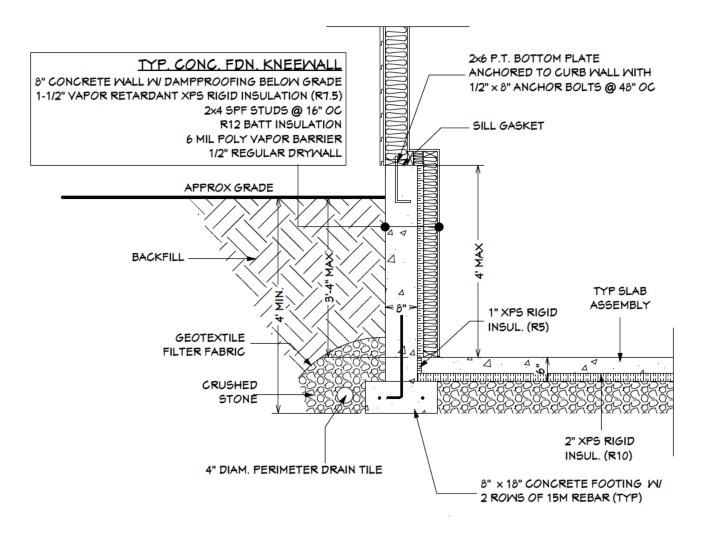


FOUNDATION DETAIL F3 CONCRETE KNEEWALL
SCALE: 1/2" = 1'-0"

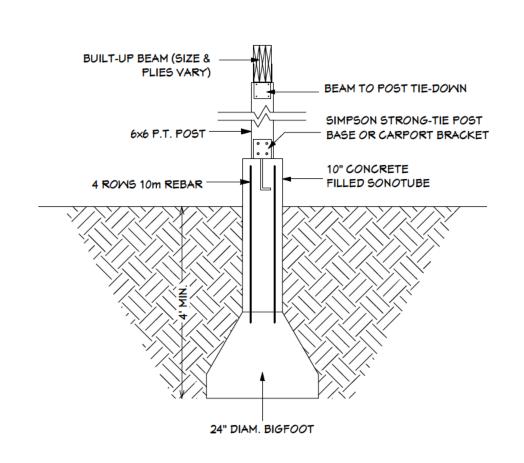

TYPICAL SONOTUBE / BEAM DETAIL

SCALE: 1/2" = 1'-0"

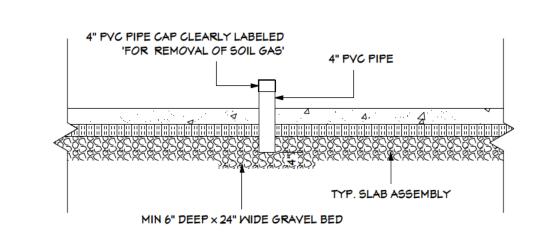

SOIL GAS ROUGH-IN DETAIL

SCALE: 1/2" = 1'-0'

N FROM CENTERLINE OF GENERAL NOTES -

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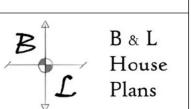
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MAY BE REQUIRED TO PROVIDE AT
THEIR EXPENSE, AN ENGINEER'S
REPORT. PLEASE CONSULT WITH
LOCAL BUILDING AUTHORITIES.

3. ERRORS AND OMISSIONS –
GREAT CARE HAS BEEN TAKEN IN THE
PRODUCTION OF PLANS FOR THIS
PROJECT, BUT THERE ALWAYS EXISTS
THE SMALL POSSIBILITY FOR ERRORS.
IT IS VERY IMPORTANT THAT THE
BUILDER CAREFULLY REVIEW & CHECK
ALL DETAILS AND INFORMATION ON
THIS PLAN INCLUDING DIMENSIONING
PRIOR TO PROCEEDING WITH
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MUST LIE WITH THE BUILDER.
HOWEVER, ANY ERRORS OR
OMISSIONS FOUND SHOULD BE
REPORTED IMMEDIATELY TO B&L
HOUSE PLANS PRIOR TO
CONSTRUCTION.

4. B&L HOUSE PLANS SHALL NOT BE RESPONSIBLE FOR EXISTING SITE CONDITIONS SUCH AS SOIL BEARING CAPACITY, WATER TABLE, BURIED STRUCTURES, OR PROXIMITY TO PROPERTY LINES.

5. CARBON MONOXIDE DETECTORS TO BE INSTALLED ON EACH LEVEL ADJACENT TO BEDROOMS AND WHERE PROPANE FIREPLACE, GAS AND WOOD BURNING APPLIANCES ARE USED.

6. ALL DRAWINGS REMAIN THE PROPERTY OF 'B&L HOUSE PLANS'



BRYDON.HUNTLEY@GMAIL.COM

PROJECT NAME -

EVERGREEN PHASE 1 6 UNIT APT. BLDG

DRAWING NAME -

FOUNDATION DETAILS

LEGEND

•	COMBO SMOKE & CARBON MONOXIDE ALARM
\oplus	SMOKE ALARM

CARBON MONOXIDE ALARM


56

SOIL GAS ROUGH-IN

REV#	REVISION		DATE
2	ISSUED FOR REVIEW		NOV 21, 202
3	ISSUED FOR CONST.		JAN 7, 2025
4	PATIO DOOR SIZE		JAN 22, 2025
5	ISSUED FOR PERMIT		APR 4, 2025
6	EGRESS WIN 5/8" DENSGL ROOF VENTS	ASS,	APR 16, 2025
7	MISC CHANGES		APR 24, 2025
8	REMOVED WET BAR		APR 28, 2025
9	FDN. REVISIONS		JUL 21, 2025
10	ADDED 3 UNITS		AUG 13, 202
SCAL	E:	SHEET:	

PAGE 12 OF 13

1/4" = 1'

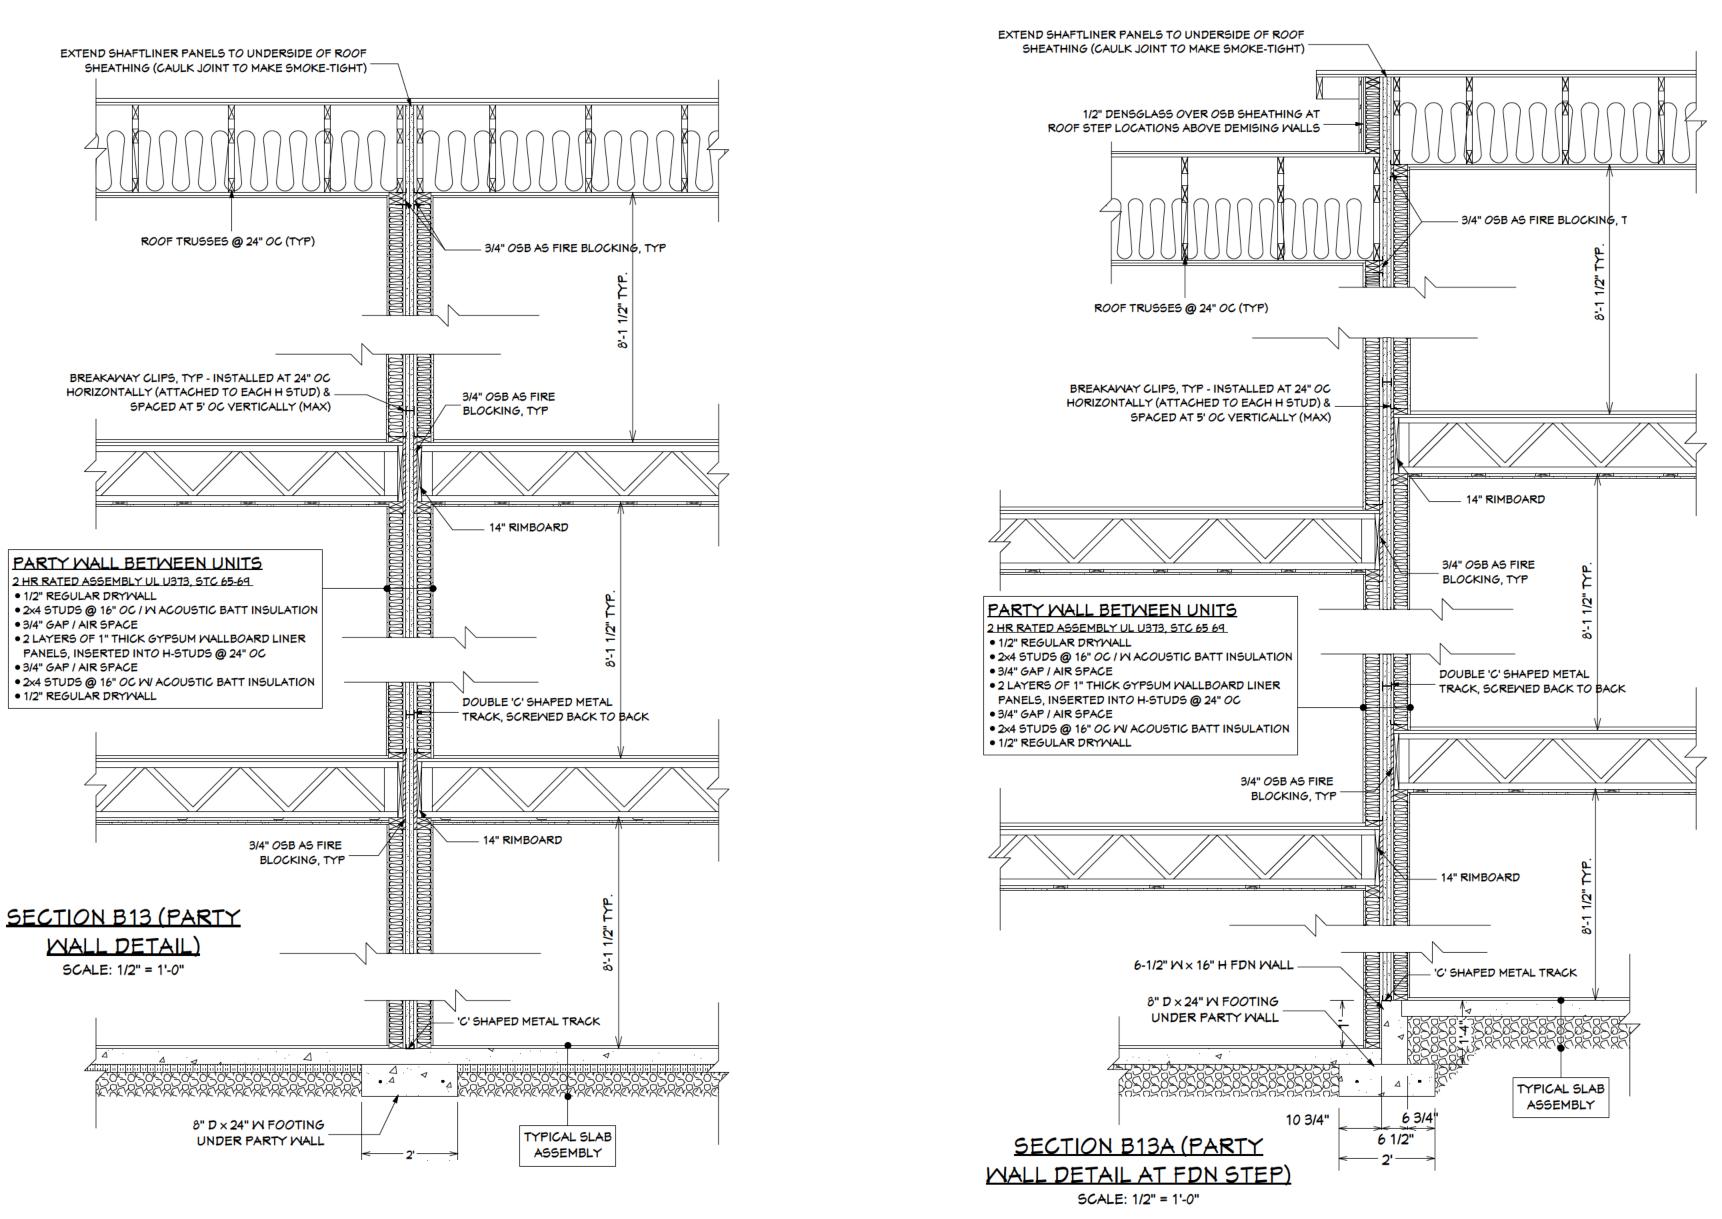

PROJECT NOTES -


- 1. FIRE SEPARATION PENETRATIONS MUST BE SEALED, TIGHTLY FITTED, FIRE STOPPED OR CONFIGURED TO MAINTAIN THE INTEGRITY OF THE SEPARATION AS PER NBCC 2015, SECTION 9.10.9.6 & 9.10.9.7
- 2. STAIRWELL HANDRAILS REQUIRE 12" HORIZONTAL PROJECTION BEYOND LAST TREAD ONE ONE SIDE OF STAIRS
- 3. PLACEMENT OF PLUMBING FIXTURES IN THE MECHANICAL ROOM MUST MEET APPLICABLE ELECTRICAL CODE & STANDARDS
- 4. SMOKE ALARMS TO CONFORM TO NBCC SUBSECTION 9.10.19

ADAPTABILITY NOTES -

- 1. MAIN UNIT ENTRANCE DOORS SHALL BE EASILY ACCESSED AND BE CAPABLE OF BEING MADE BARRIER FREE FROM PARKING AREA OR SIDEWALK IN ORDER TO COMPLY WITH ADAPTABLE HOUSING
- 2. ALL UNITS TO COMPLY WITH <u>ADAPTABLE HOUSING REQUIREMENTS</u> (AHR)
- 3. ALL UNIT ENTRANCE DOORS SHALL BE LOW THRESHOLD (MAX 1/2") & BE EQUIPPED WITH HARDWARE CONFORMING TO AHR
- 4. ALL UNIT INTERIOR DOORS SHALL BE EQUIPPED WITH DOOR OPENING HARDWARE CONFORMING TO AHR
- 5. KITCHEN CONTROLS, PLUMBING & ELECTRICAL TO CONFORM WITH AHR
- 6. BATHROOM CONTROLS & HARDWARE SHALL CONFORM TO AHR
- 7. WALL ASSEMBLIES ENCLOSING BATHROOM TO INCLUDE REINFORCEMENT TO ALLOW FUTURE INSTALLATION OF GRAB BARS CONFORMING TO AHR

ROM CENTERLINE OF GENERAL NOTES -

- 1. BUILDER QUALIFICATIONS THIS PLAN IS INTENDED FOR USE BY
 PERSONS KNOWLEDGEABLE IN AND
 FAMILIAR WITH GENERALLY ACCEPTED
 METHODS, TECHNIQUES AND
 STANDARDS NECESSARY FOR THE
 CONSTRUCTION OF THIS STRUCTURE.
- 2. BUILDING CODES -- ALL WORK TO BE COMPLETED IN ACCORDANCE WITH THE CURRENT NATIONAL BUILDING CODE OF CANADA - ALL FEDERAL, PROVINCIAL AND LOCAL ORDINANCES, ETC., SHALL BE CONSIDERED AS SPECIFICATIONS FOR THIS STRUCTURE AND SHALL TAKE PRECEDENCE OVER ANYTHING SHOWN, DESCRIBED OR IMPLIED, IF AND WHERE VARIANCES OCCUR.
 - IN THE CASE OF HIGH SNOW LOADS OR UNUSUAL SITE CONDITIONS, NON-STANDARD FOUNDATIONS OR BEAM SIZES BEYOND THE SCOPE OF NBC PART 9 TABLES, THE OWNER / BUILDER MAY BE REQUIRED TO PROVIDE AT THEIR EXPENSE, AN ENGINEER'S REPORT. PLEASE CONSULT WITH LOCAL BUILDING AUTHORITIES.
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PROJECT NAME

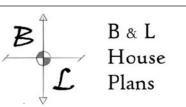EVERGREEN PHASE 1 6 UNIT APT. BLDG

DRAWING NAME -

SECTION B13 & PROJECT NOTES

LEGEND

•	COMBO SMOKE & CARBON MONOXIDE ALARM

CARBON MONOXIDE ALARM

SMOKE ALARM

(CARBON MONOXIDE ALARM

SOIL GAS ROUGH-IN

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